

A66 Northern Trans-Pennine Project

Scheme 07: Bowes Bypass

TR010062


5.17 Engineering Section Drawings
(Plan and Profiles)


APFP Regulations 5(2)(o) and 6(2)


Planning Act 2008


Infrastructure Planning (Applications: Prescribed Forms and Procedure) Regulations 2009


June 2022

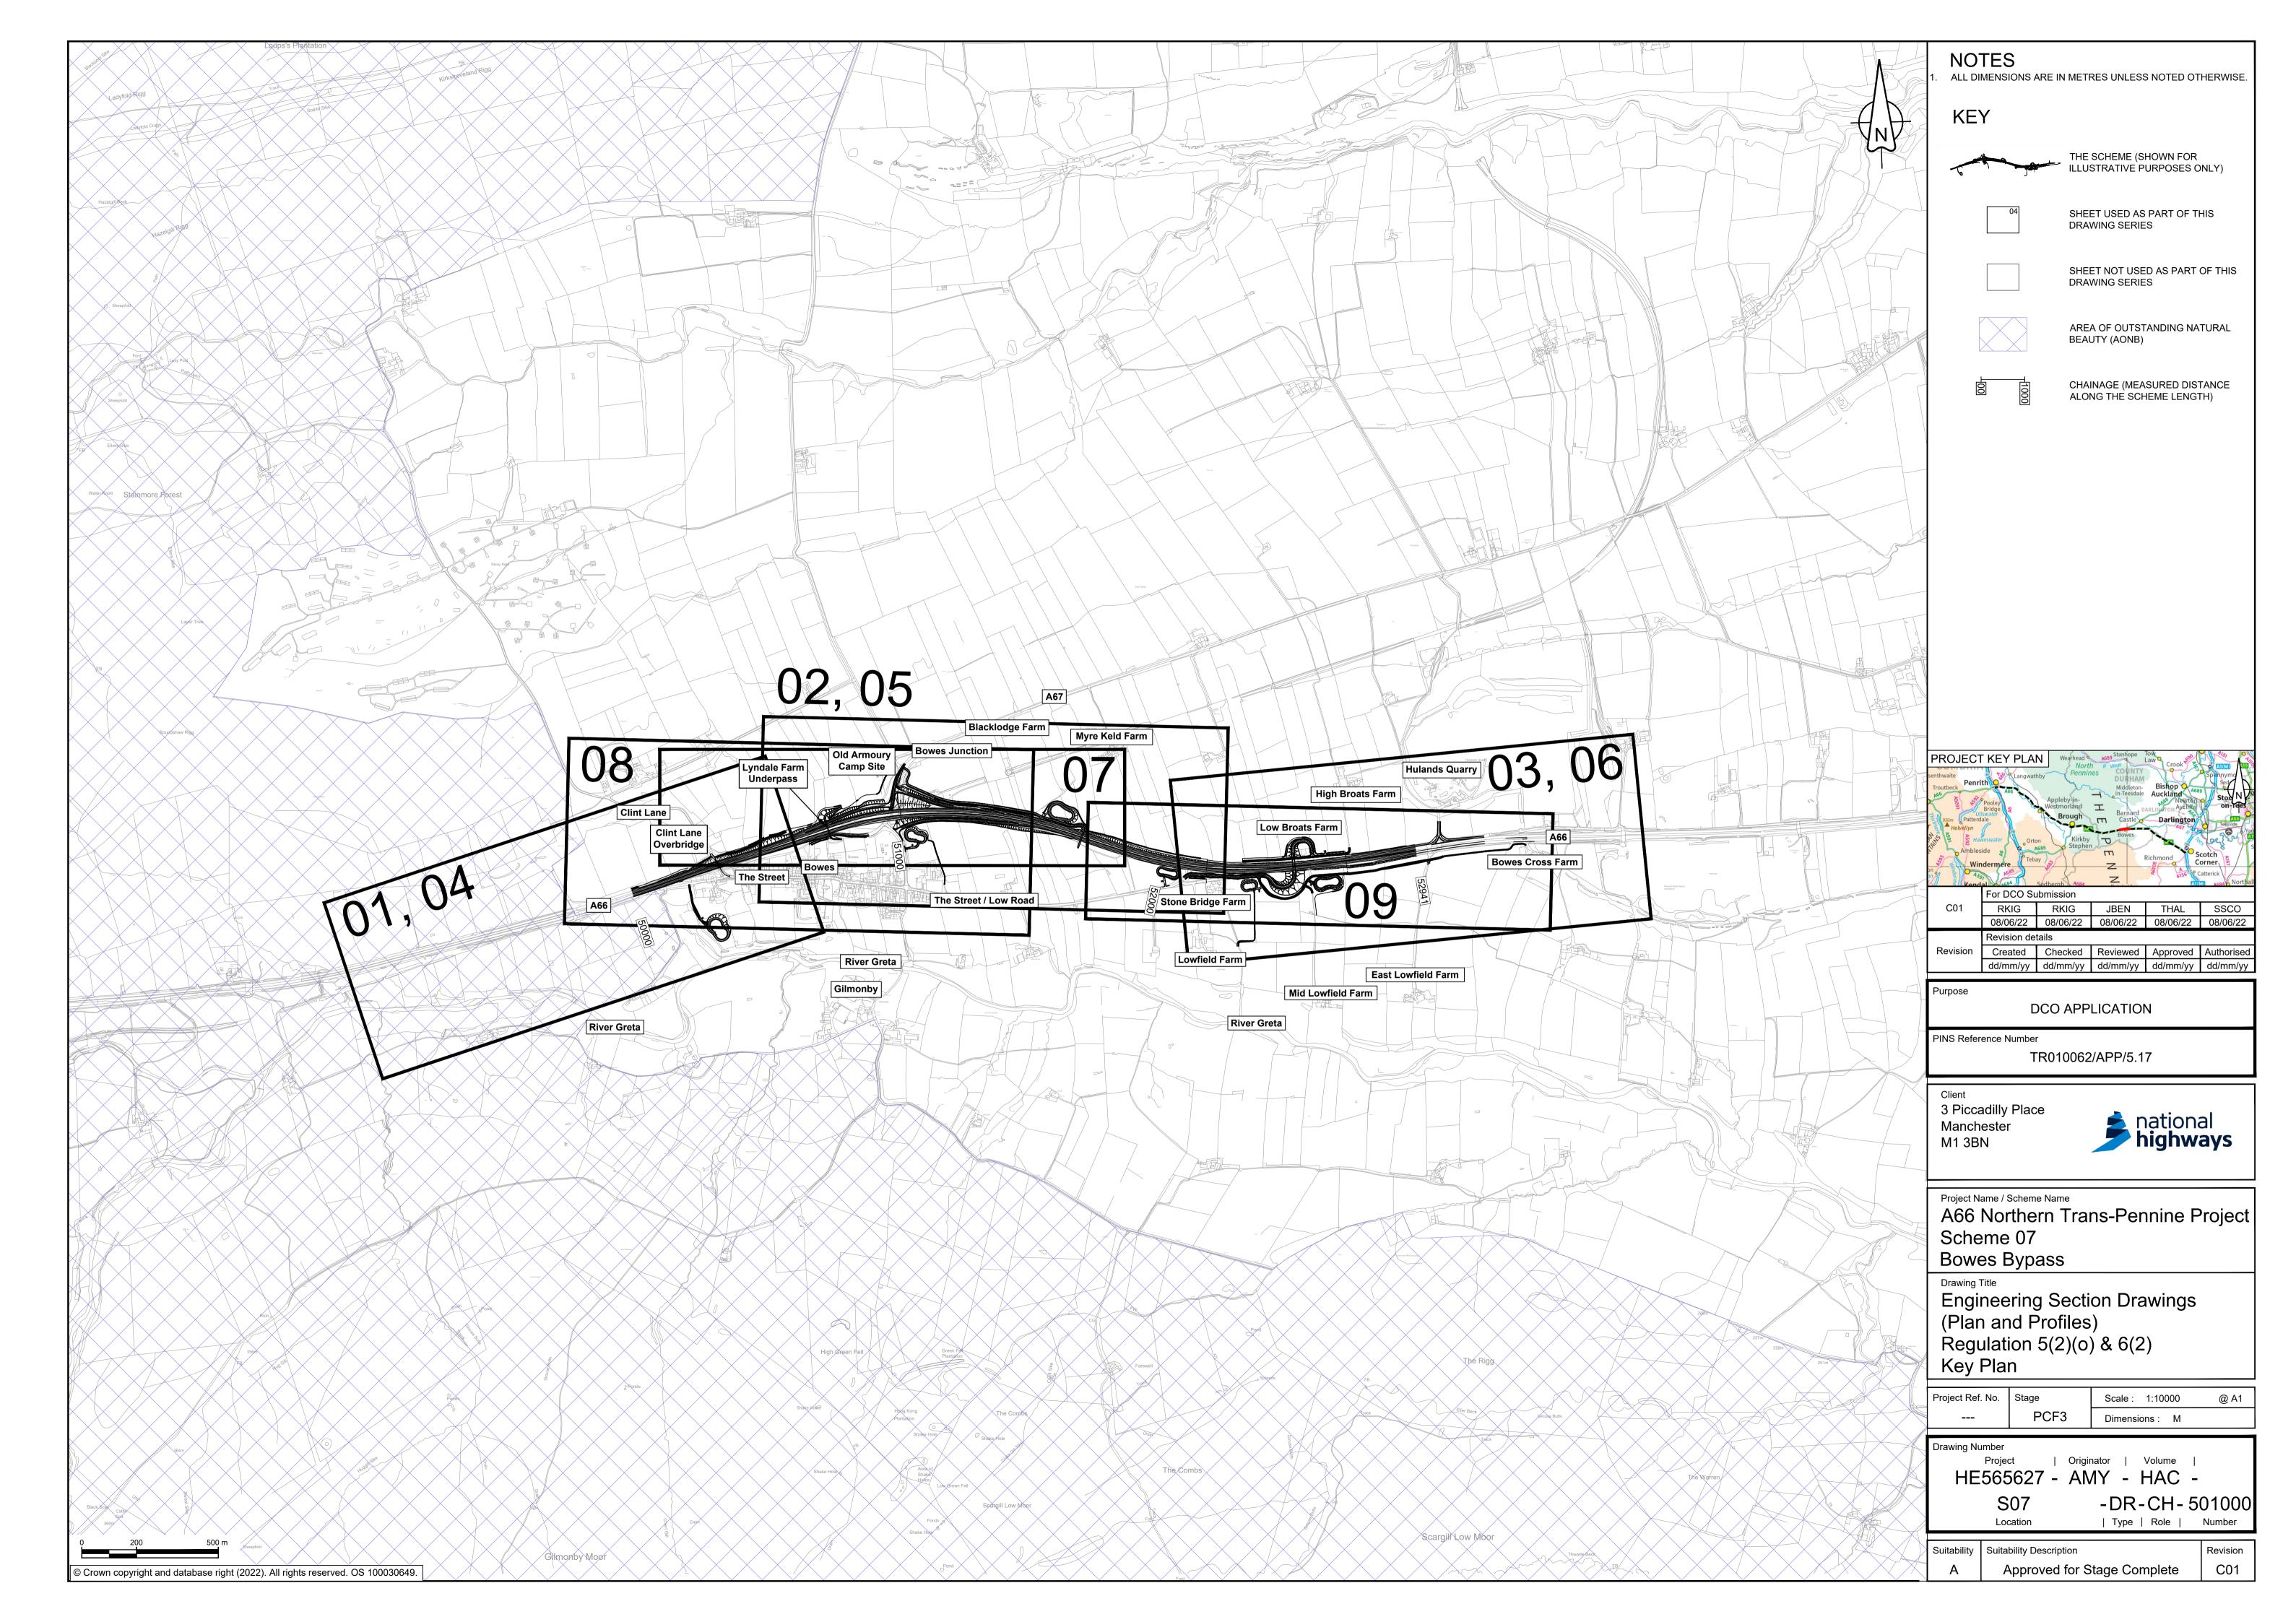

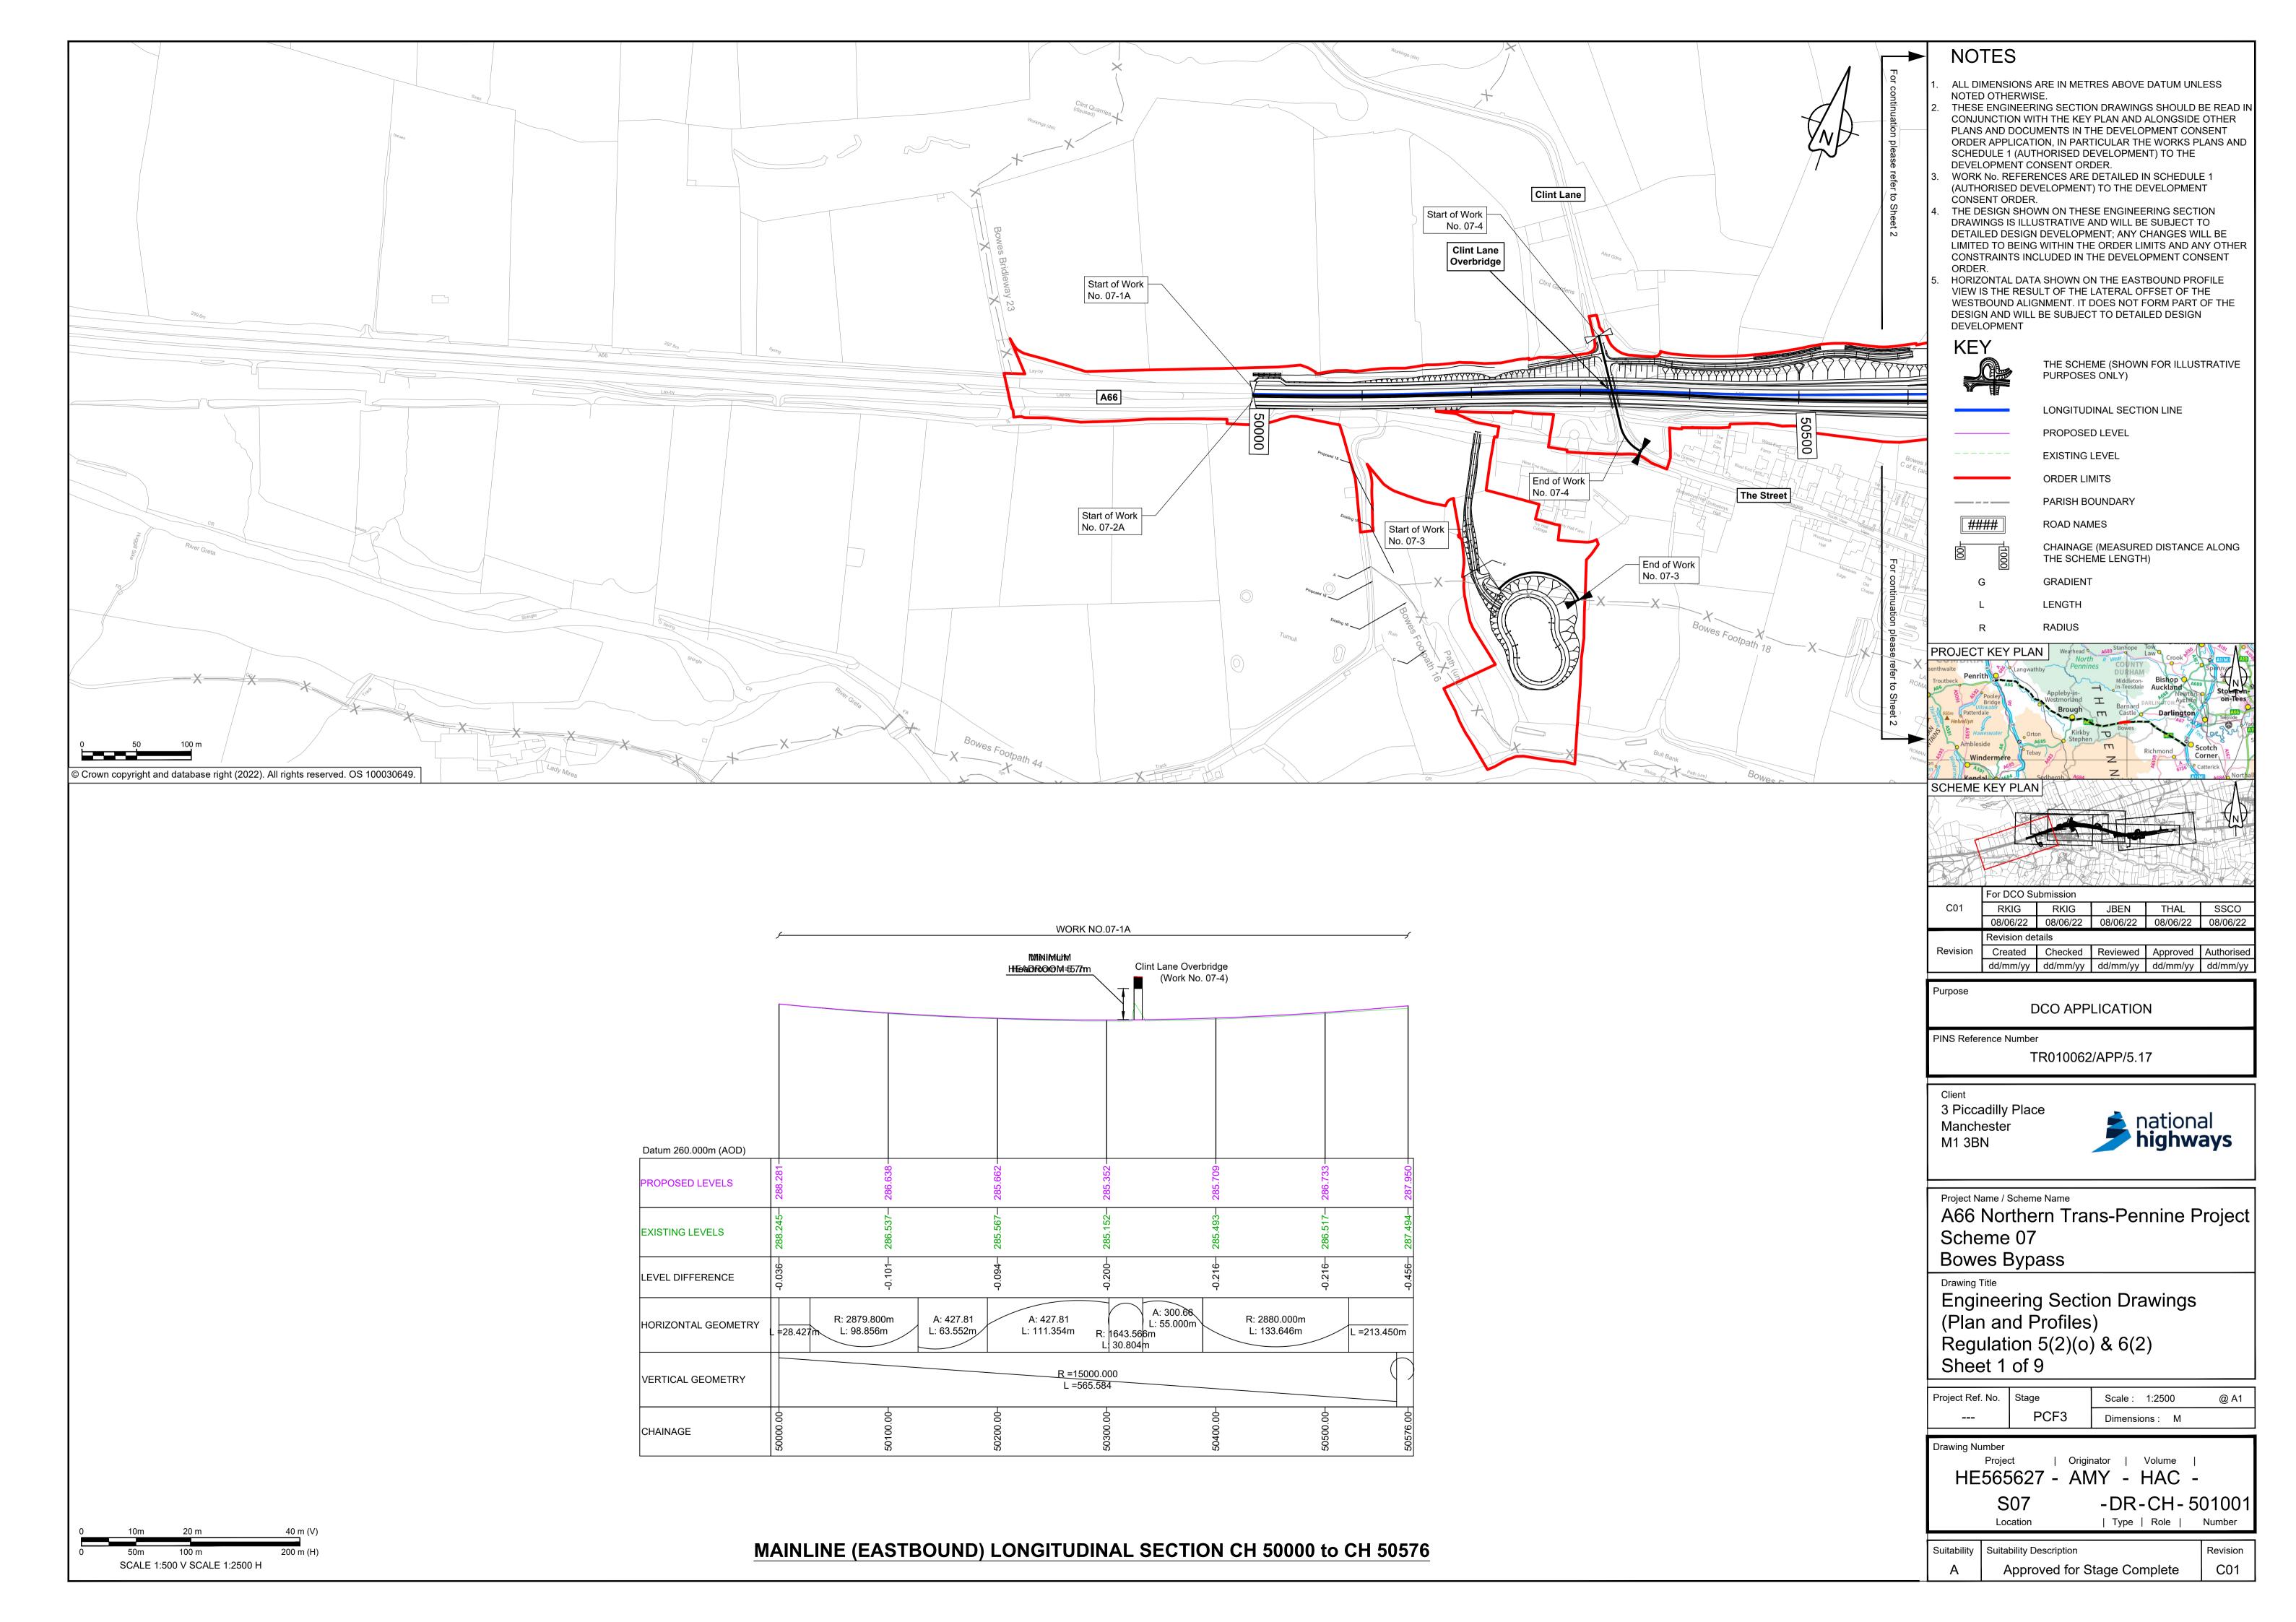

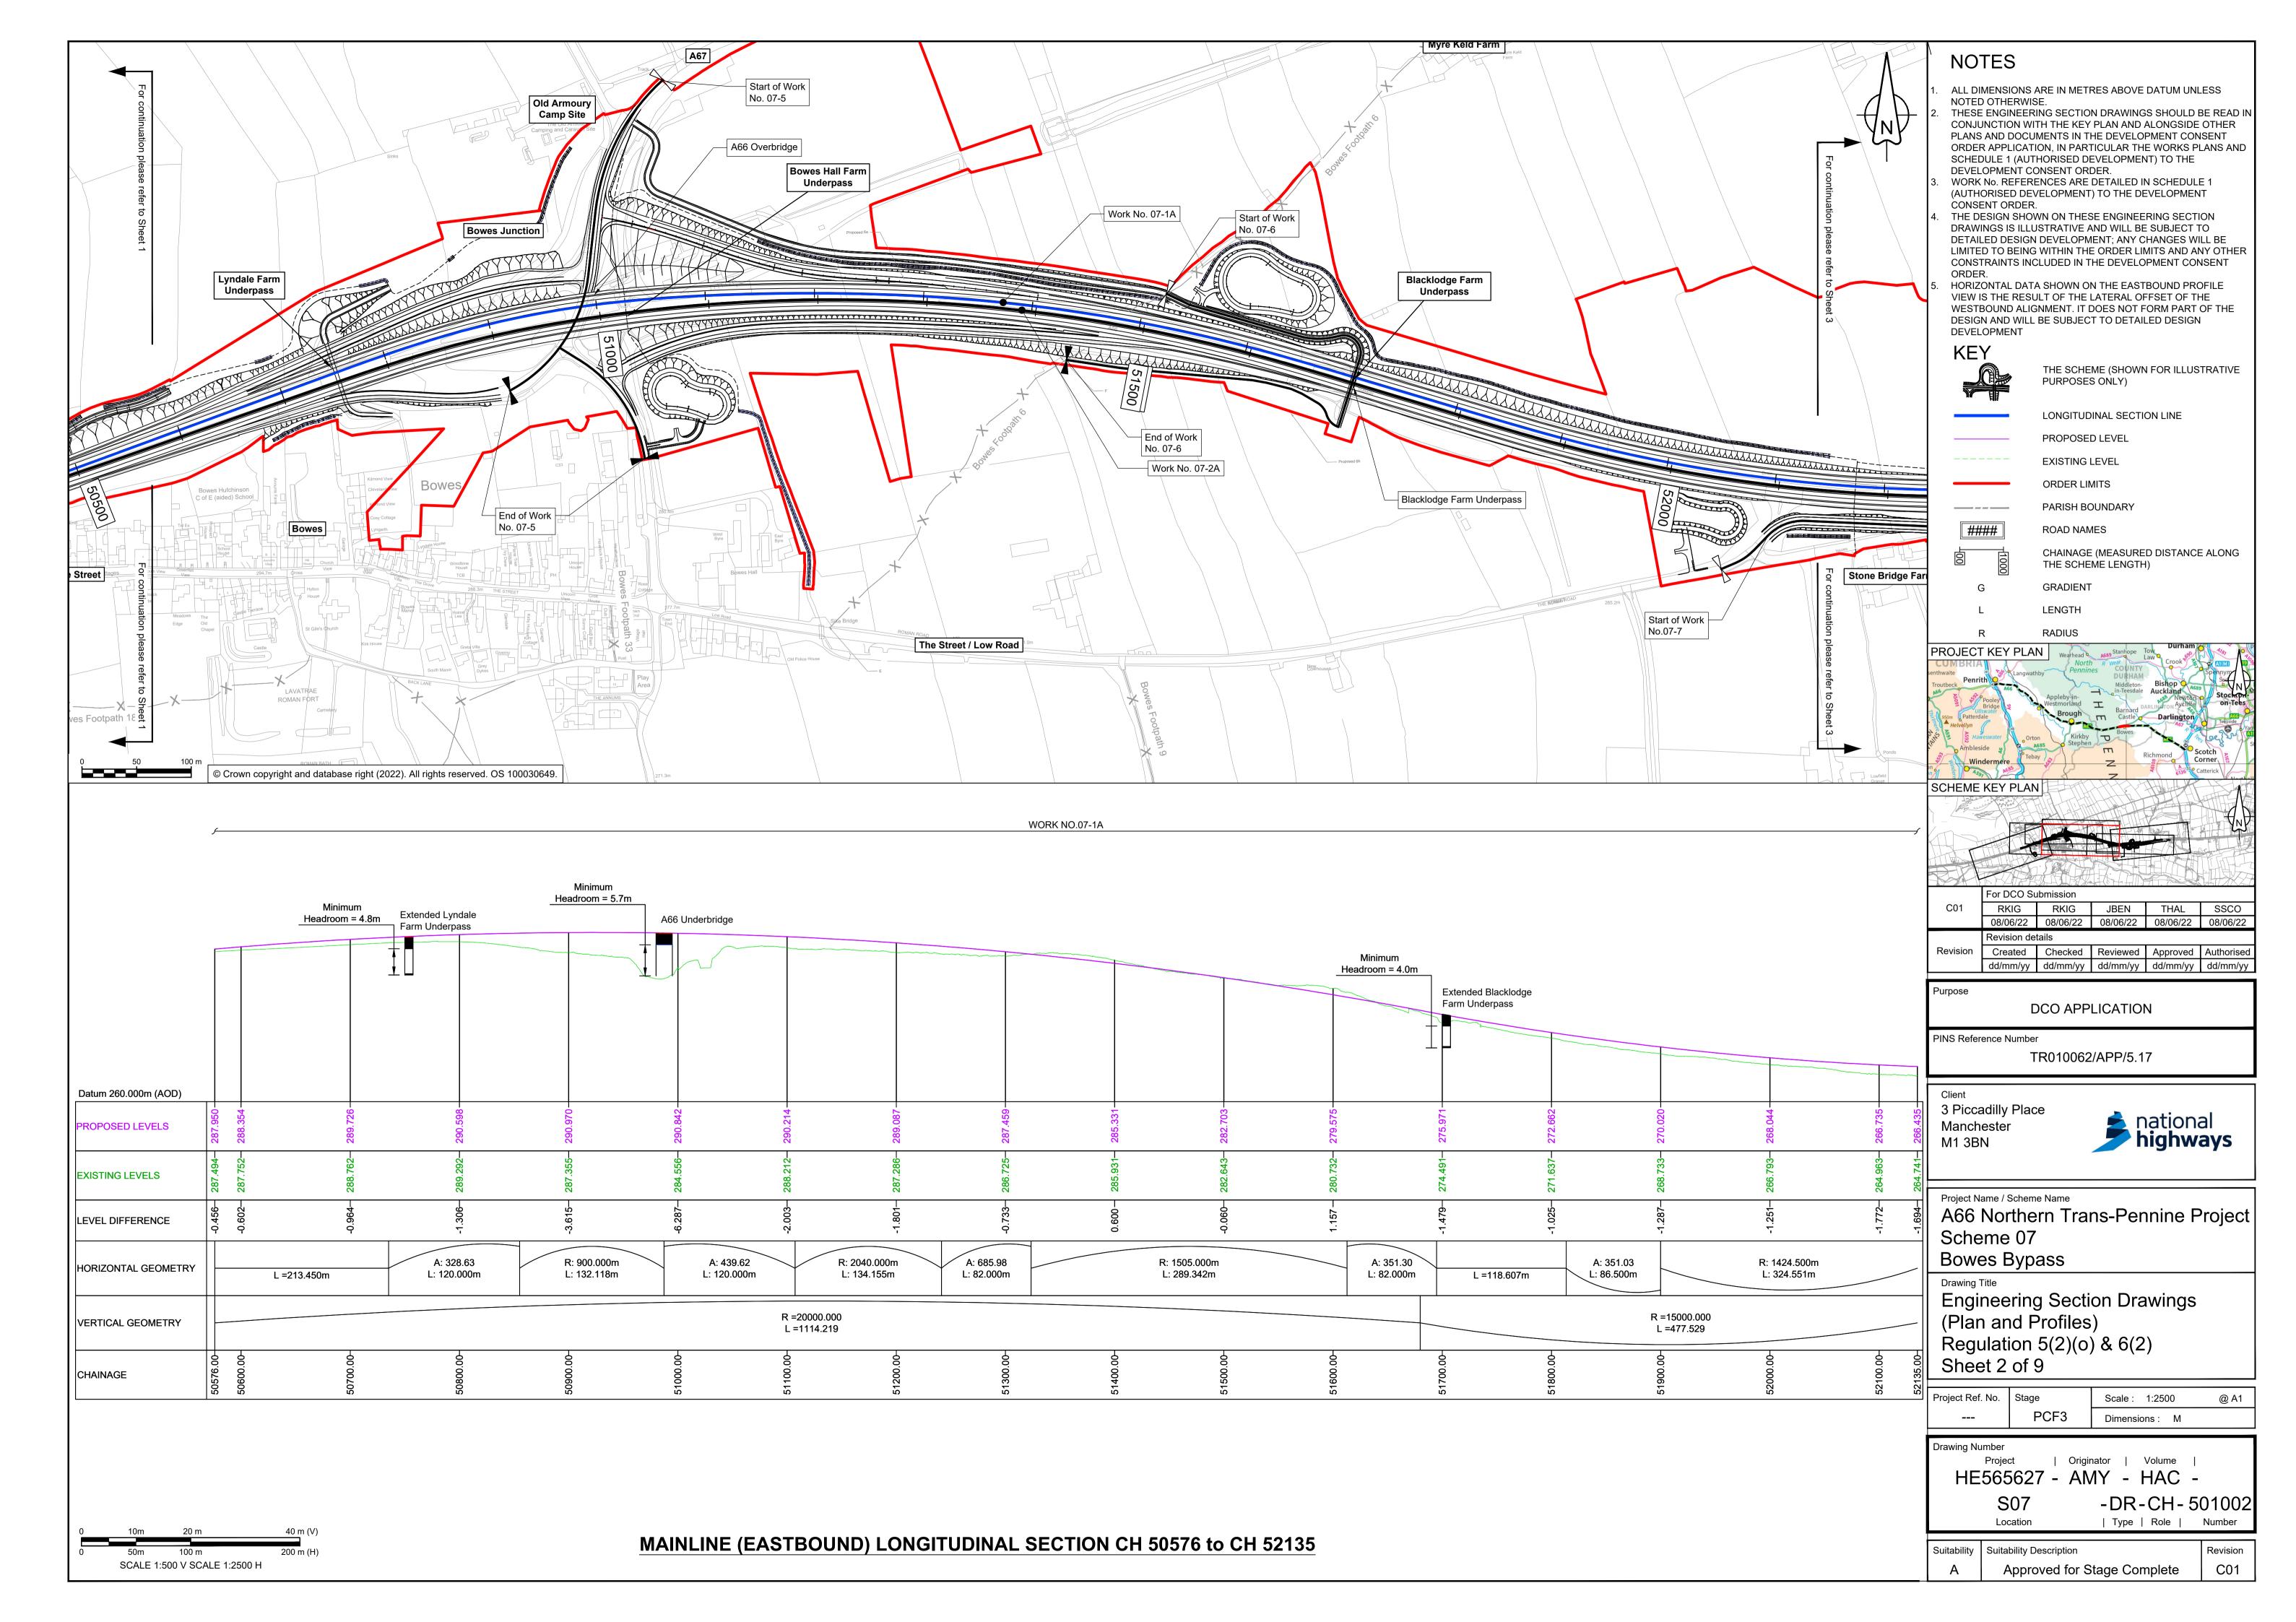

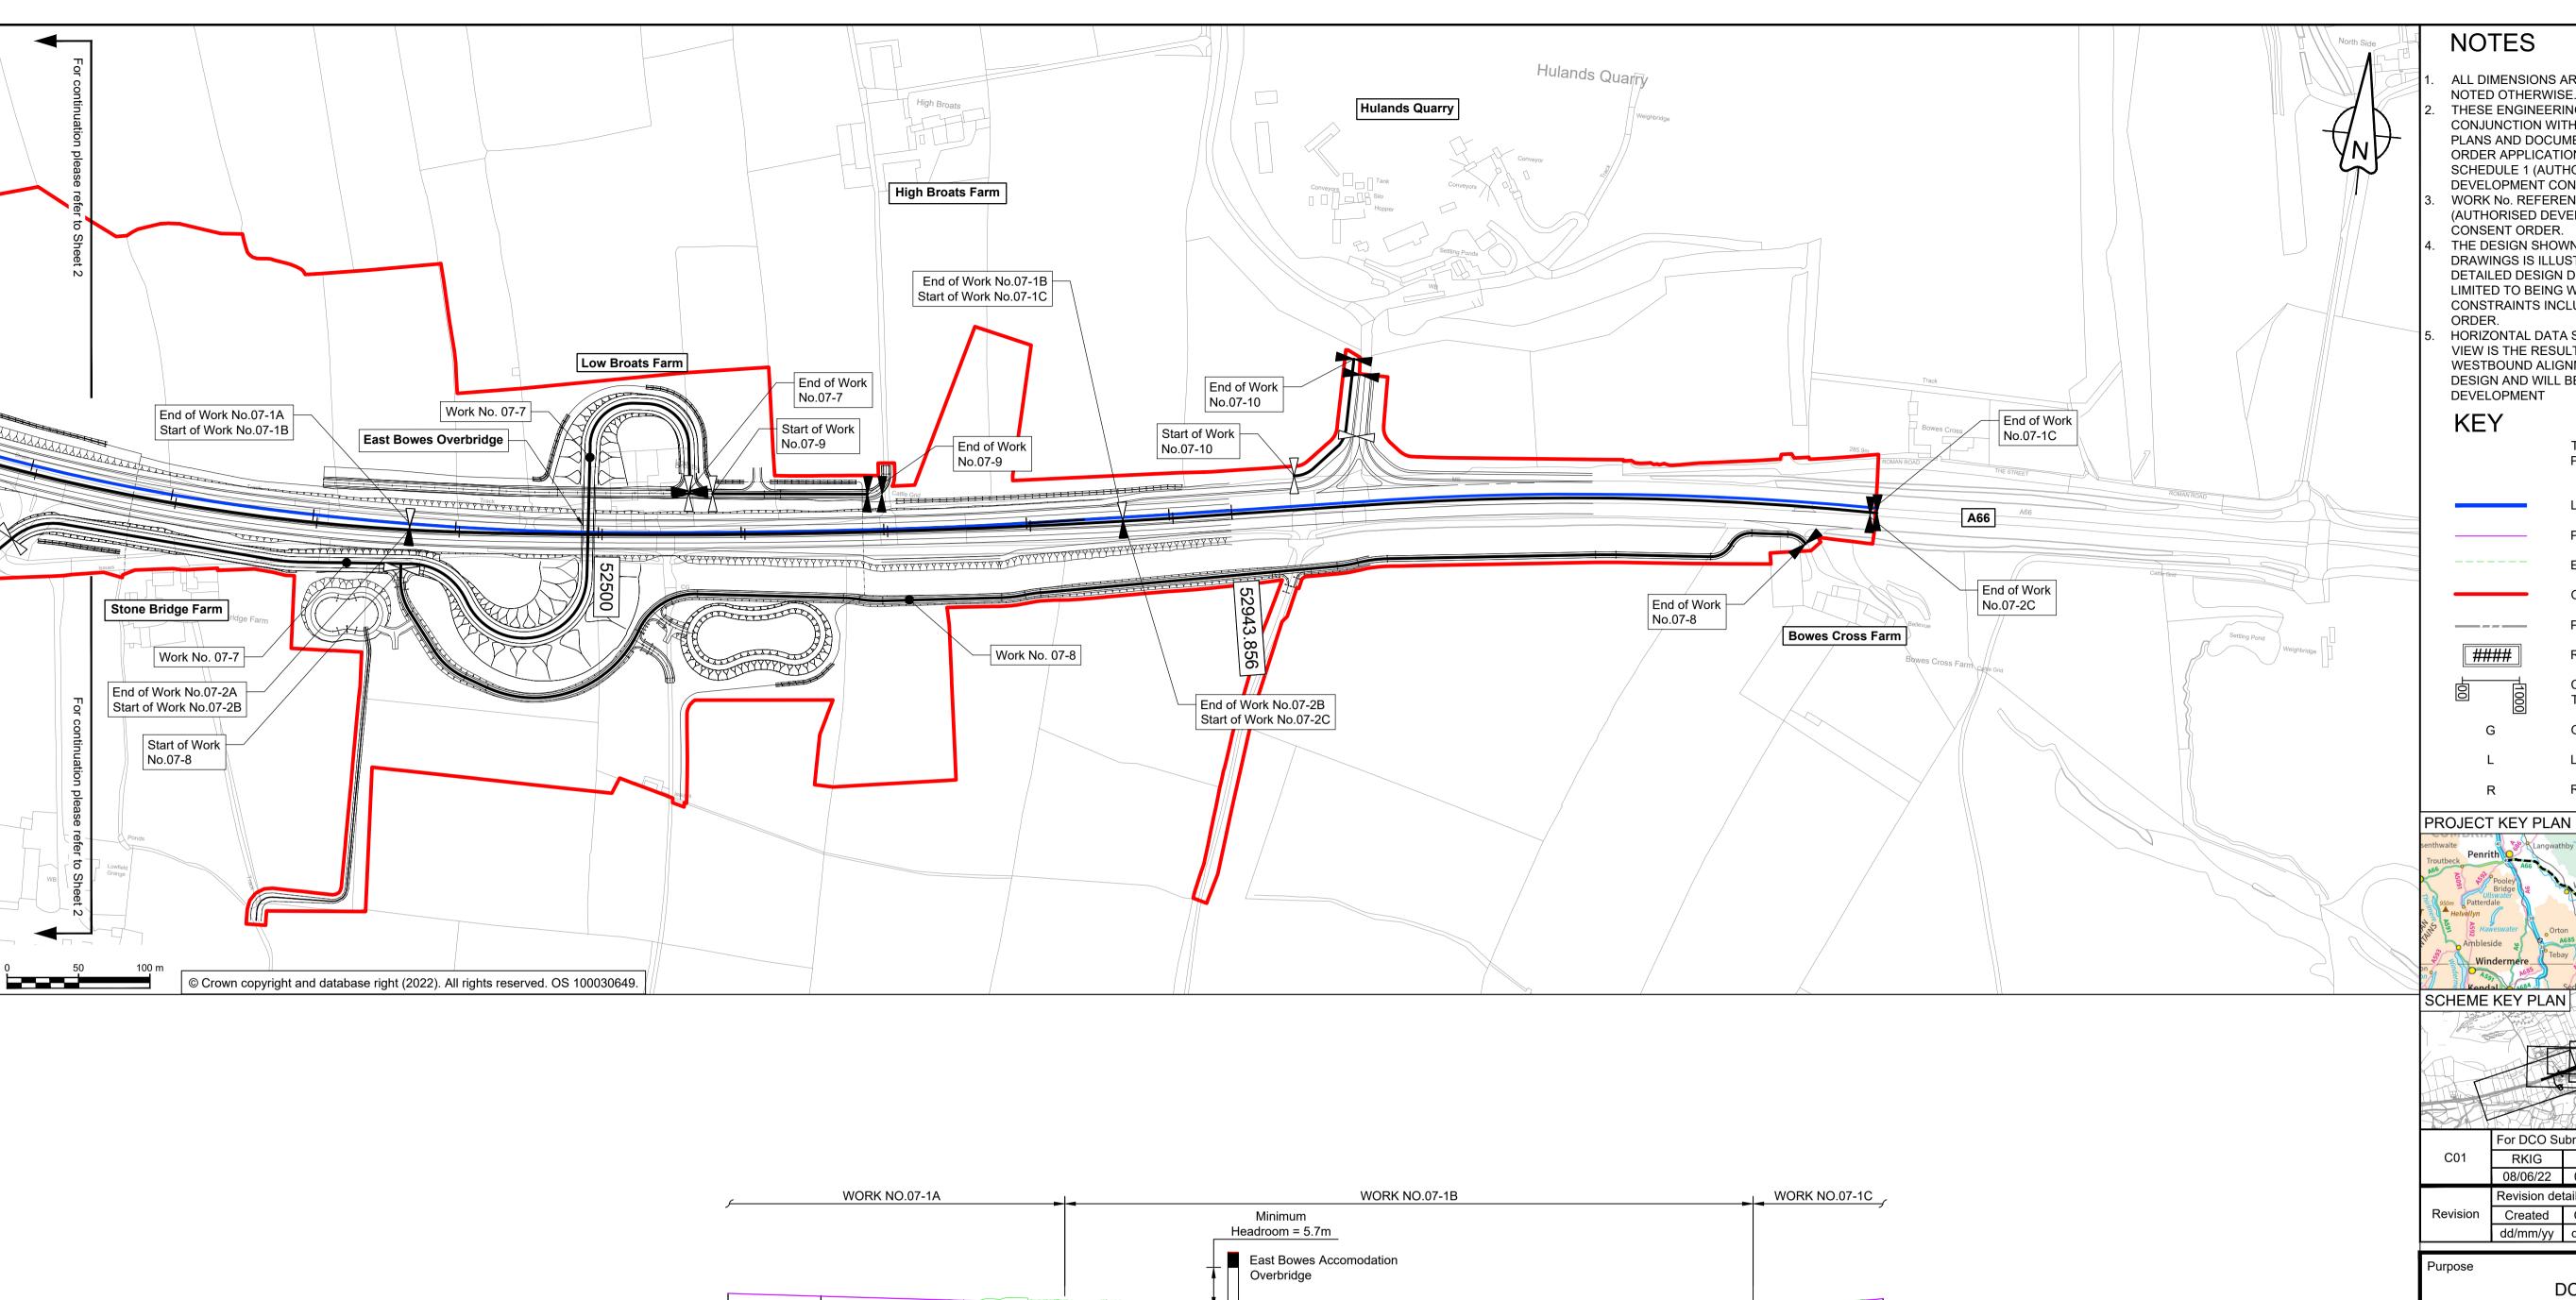

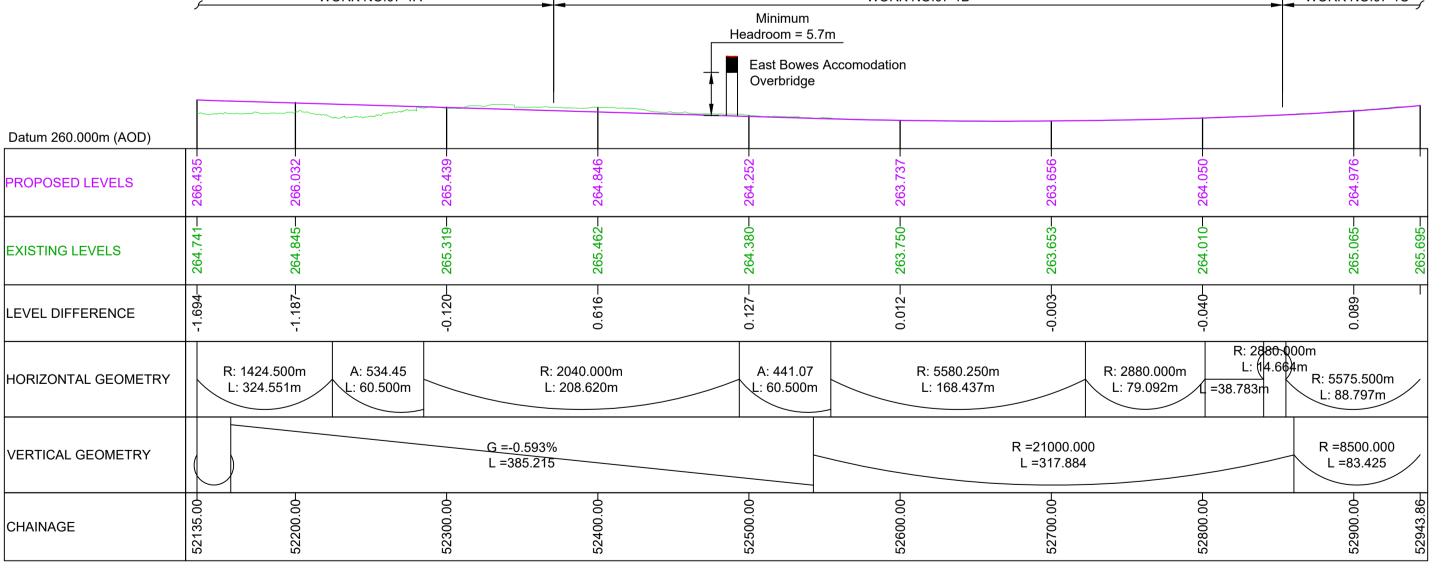

- ALL DIMENSIONS ARE IN METRES ABOVE DATUM UNLESS
- THESE ENGINEERING SECTION DRAWINGS SHOULD BE READ IN CONJUNCTION WITH THE KEY PLAN AND ALONGSIDE OTHER PLANS AND DOCUMENTS IN THE DEVELOPMENT CONSENT ORDER APPLICATION, IN PARTICULAR THE WORKS PLANS AND SCHEDULE 1 (AUTHORISED DEVELOPMENT) TO THE DEVELOPMENT CONSENT ORDER.
- WORK No. REFERENCES ARE DETAILED IN SCHEDULE 1 (AUTHORISED DEVELOPMENT) TO THE DEVELOPMENT CONSENT ORDER.
- THE DESIGN SHOWN ON THESE ENGINEERING SECTION DRAWINGS IS ILLUSTRATIVE AND WILL BE SUBJECT TO DETAILED DESIGN DEVELOPMENT; ANY CHANGES WILL BE LIMITED TO BEING WITHIN THE ORDER LIMITS AND ANY OTHER CONSTRAINTS INCLUDED IN THE DEVELOPMENT CONSENT
- HORIZONTAL DATA SHOWN ON THE EASTBOUND PROFILE VIEW IS THE RESULT OF THE LATERAL OFFSET OF THE WESTBOUND ALIGNMENT. IT DOES NOT FORM PART OF THE DESIGN AND WILL BE SUBJECT TO DETAILED DESIGN

THE SCHEME (SHOWN FOR ILLUSTRATIVE PURPOSES ONLY)

LONGITUDINAL SECTION LINE

PROPOSED LEVEL

EXISTING LEVEL ORDER LIMITS

PARISH BOUNDARY

ROAD NAMES CHAINAGE (MEASURED DISTANCE ALONG

THE SCHEME LENGTH)

GRADIENT

LENGTH

RADIUS

PROJECT KEY PLAN

For DCO Submission RKIG RKIG JBEN THAL SSCO 08/06/22 08/06/22 08/06/22 08/06/22

Revision details Created Checked Reviewed Approved Authorised dd/mm/yy dd/mm/yy dd/mm/yy dd/mm/yy

DCO APPLICATION

PINS Reference Number

TR010062/APP/5.17

3 Piccadilly Place Manchester M1 3BN



Project Name / Scheme Name

A66 Northern Trans-Pennine Project Scheme 07

Bowes Bypass

Engineering Section Drawings (Plan and Profiles) Regulation 5(2)(o) & 6(2) Sheet 3 of 9

Project Ref. No. Scale: 1:2500 @ A1 Dimensions: M

Drawing Number

| Originator | Volume | HE565627 - AMY - HAC -


Location


-DR-CH-501003 | Type | Role |


Suitability | Suitability Description Revision Approved for Stage Complete C01

MAINLINE (EASTBOUND) LONGITUDINAL SECTION CH 52135 to CH 52943

SCALE 1:500 V SCALE 1:2500 H

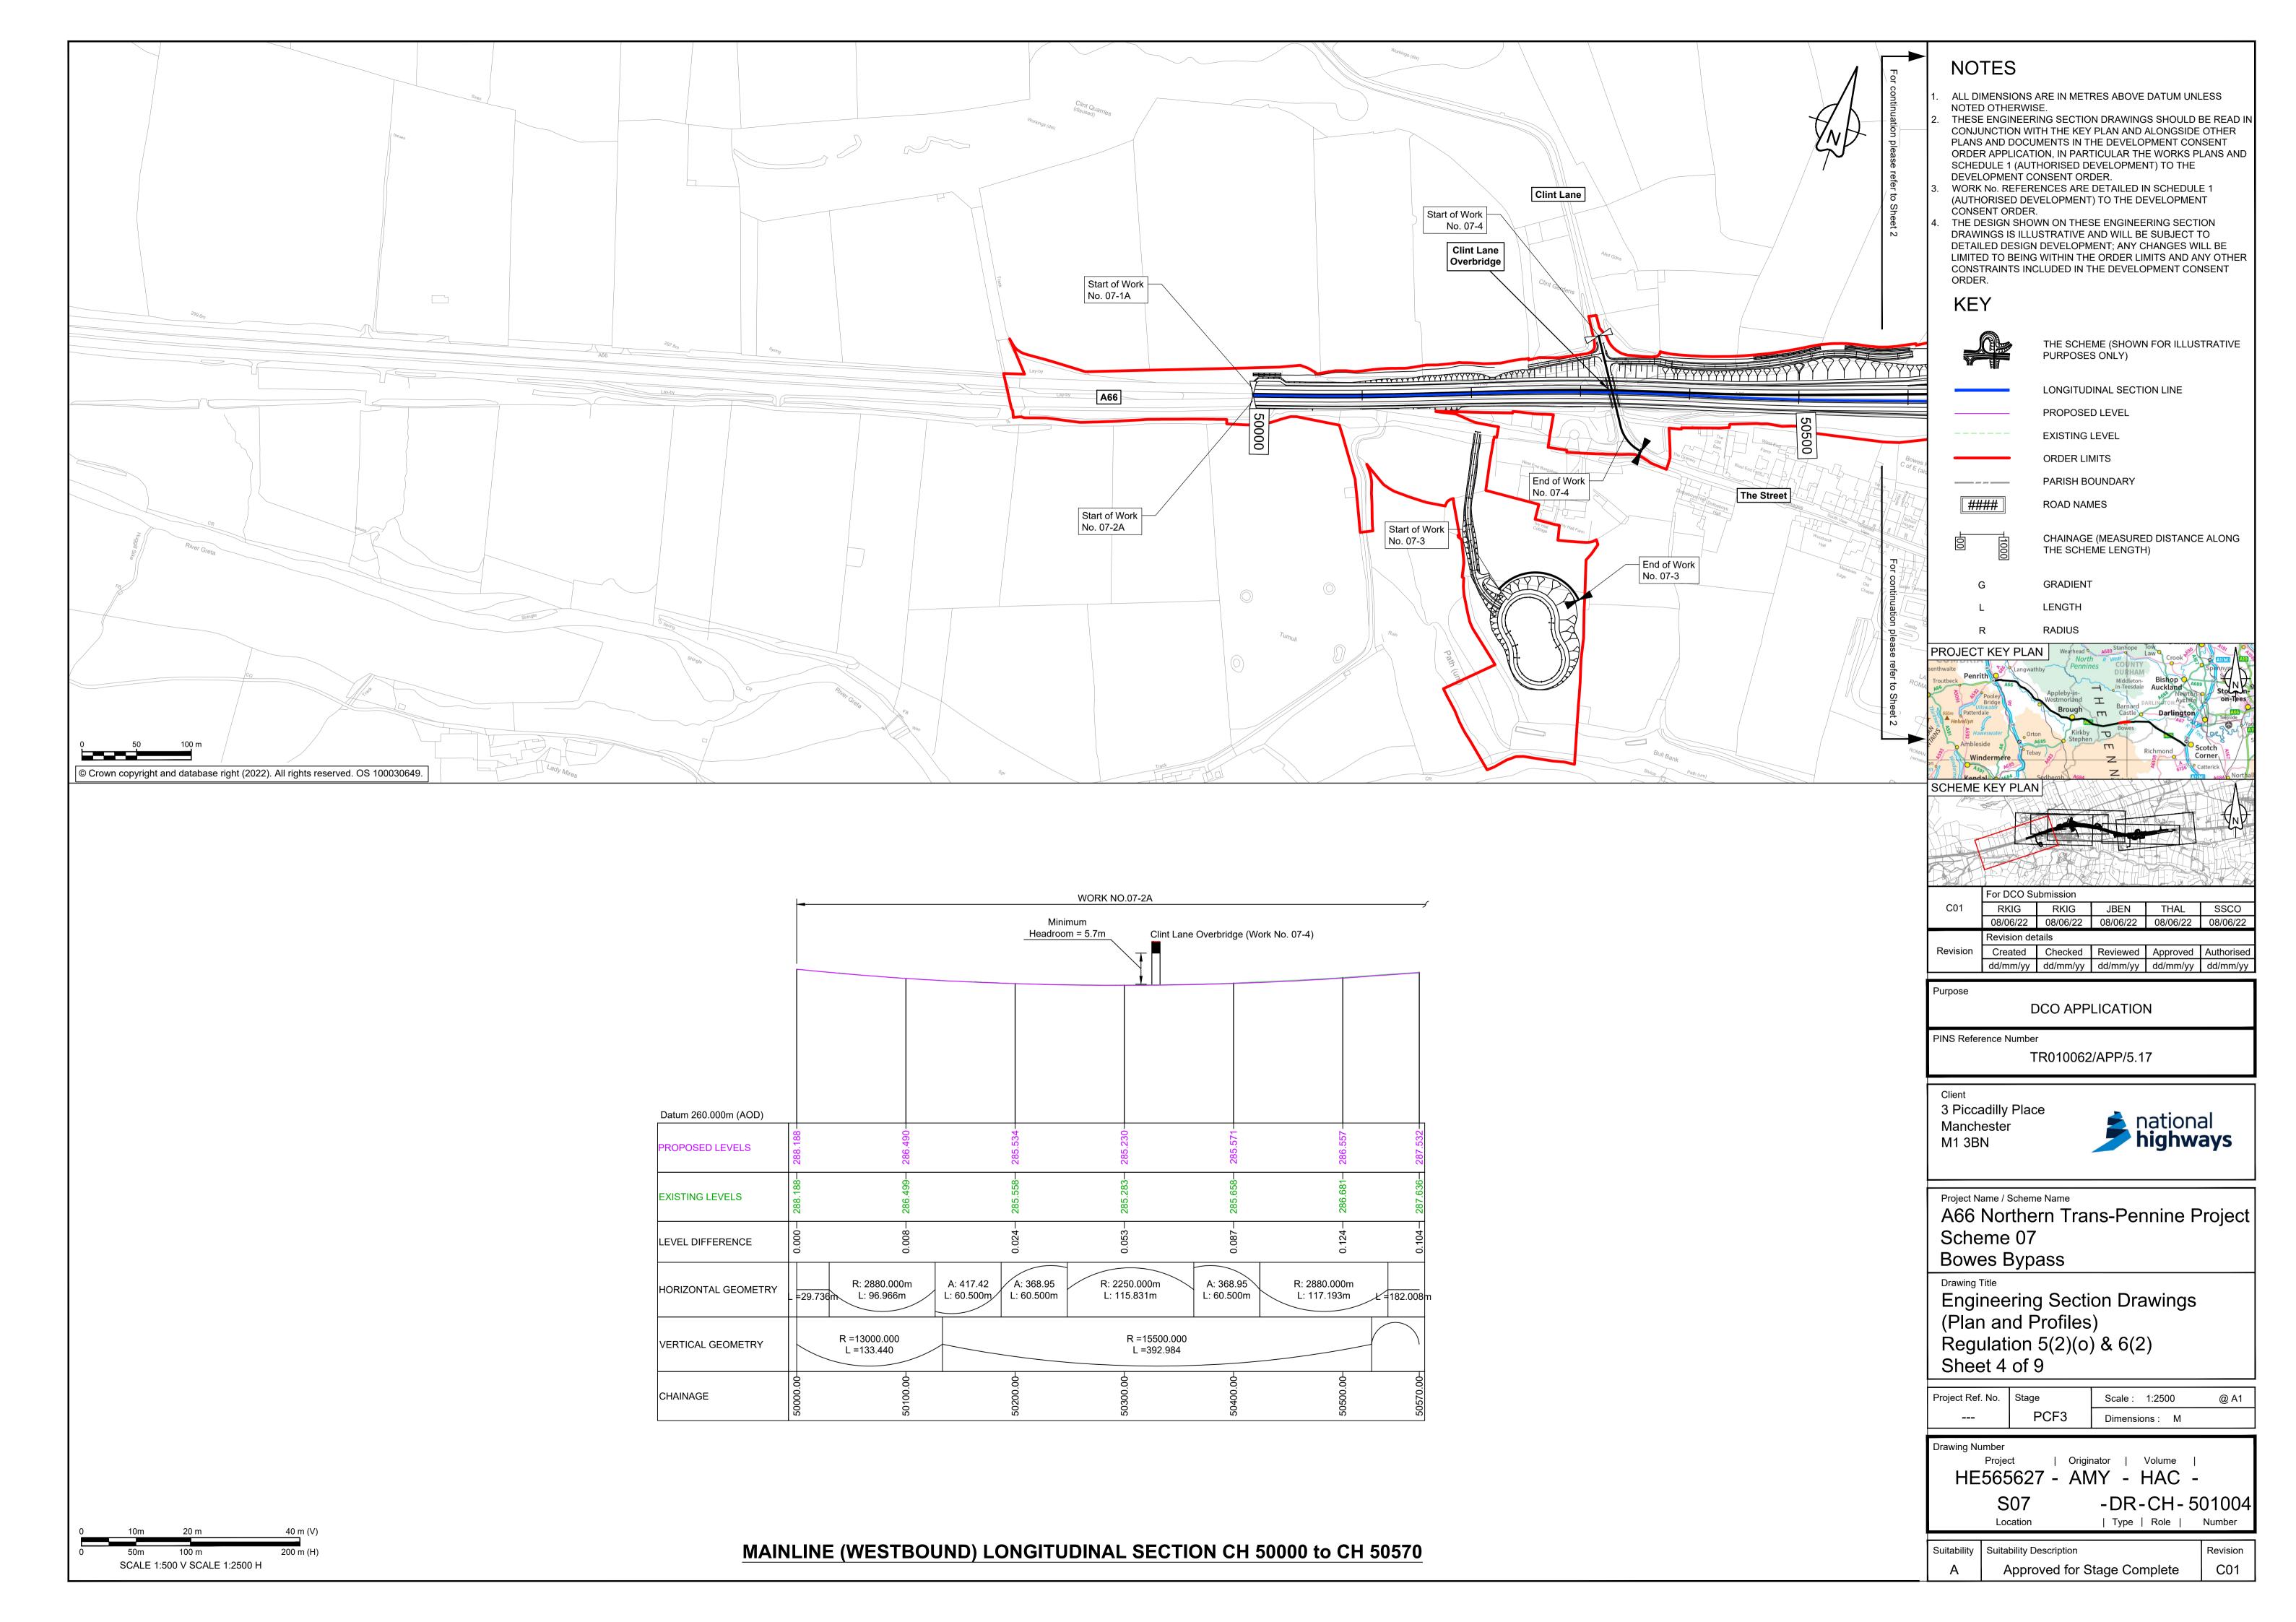

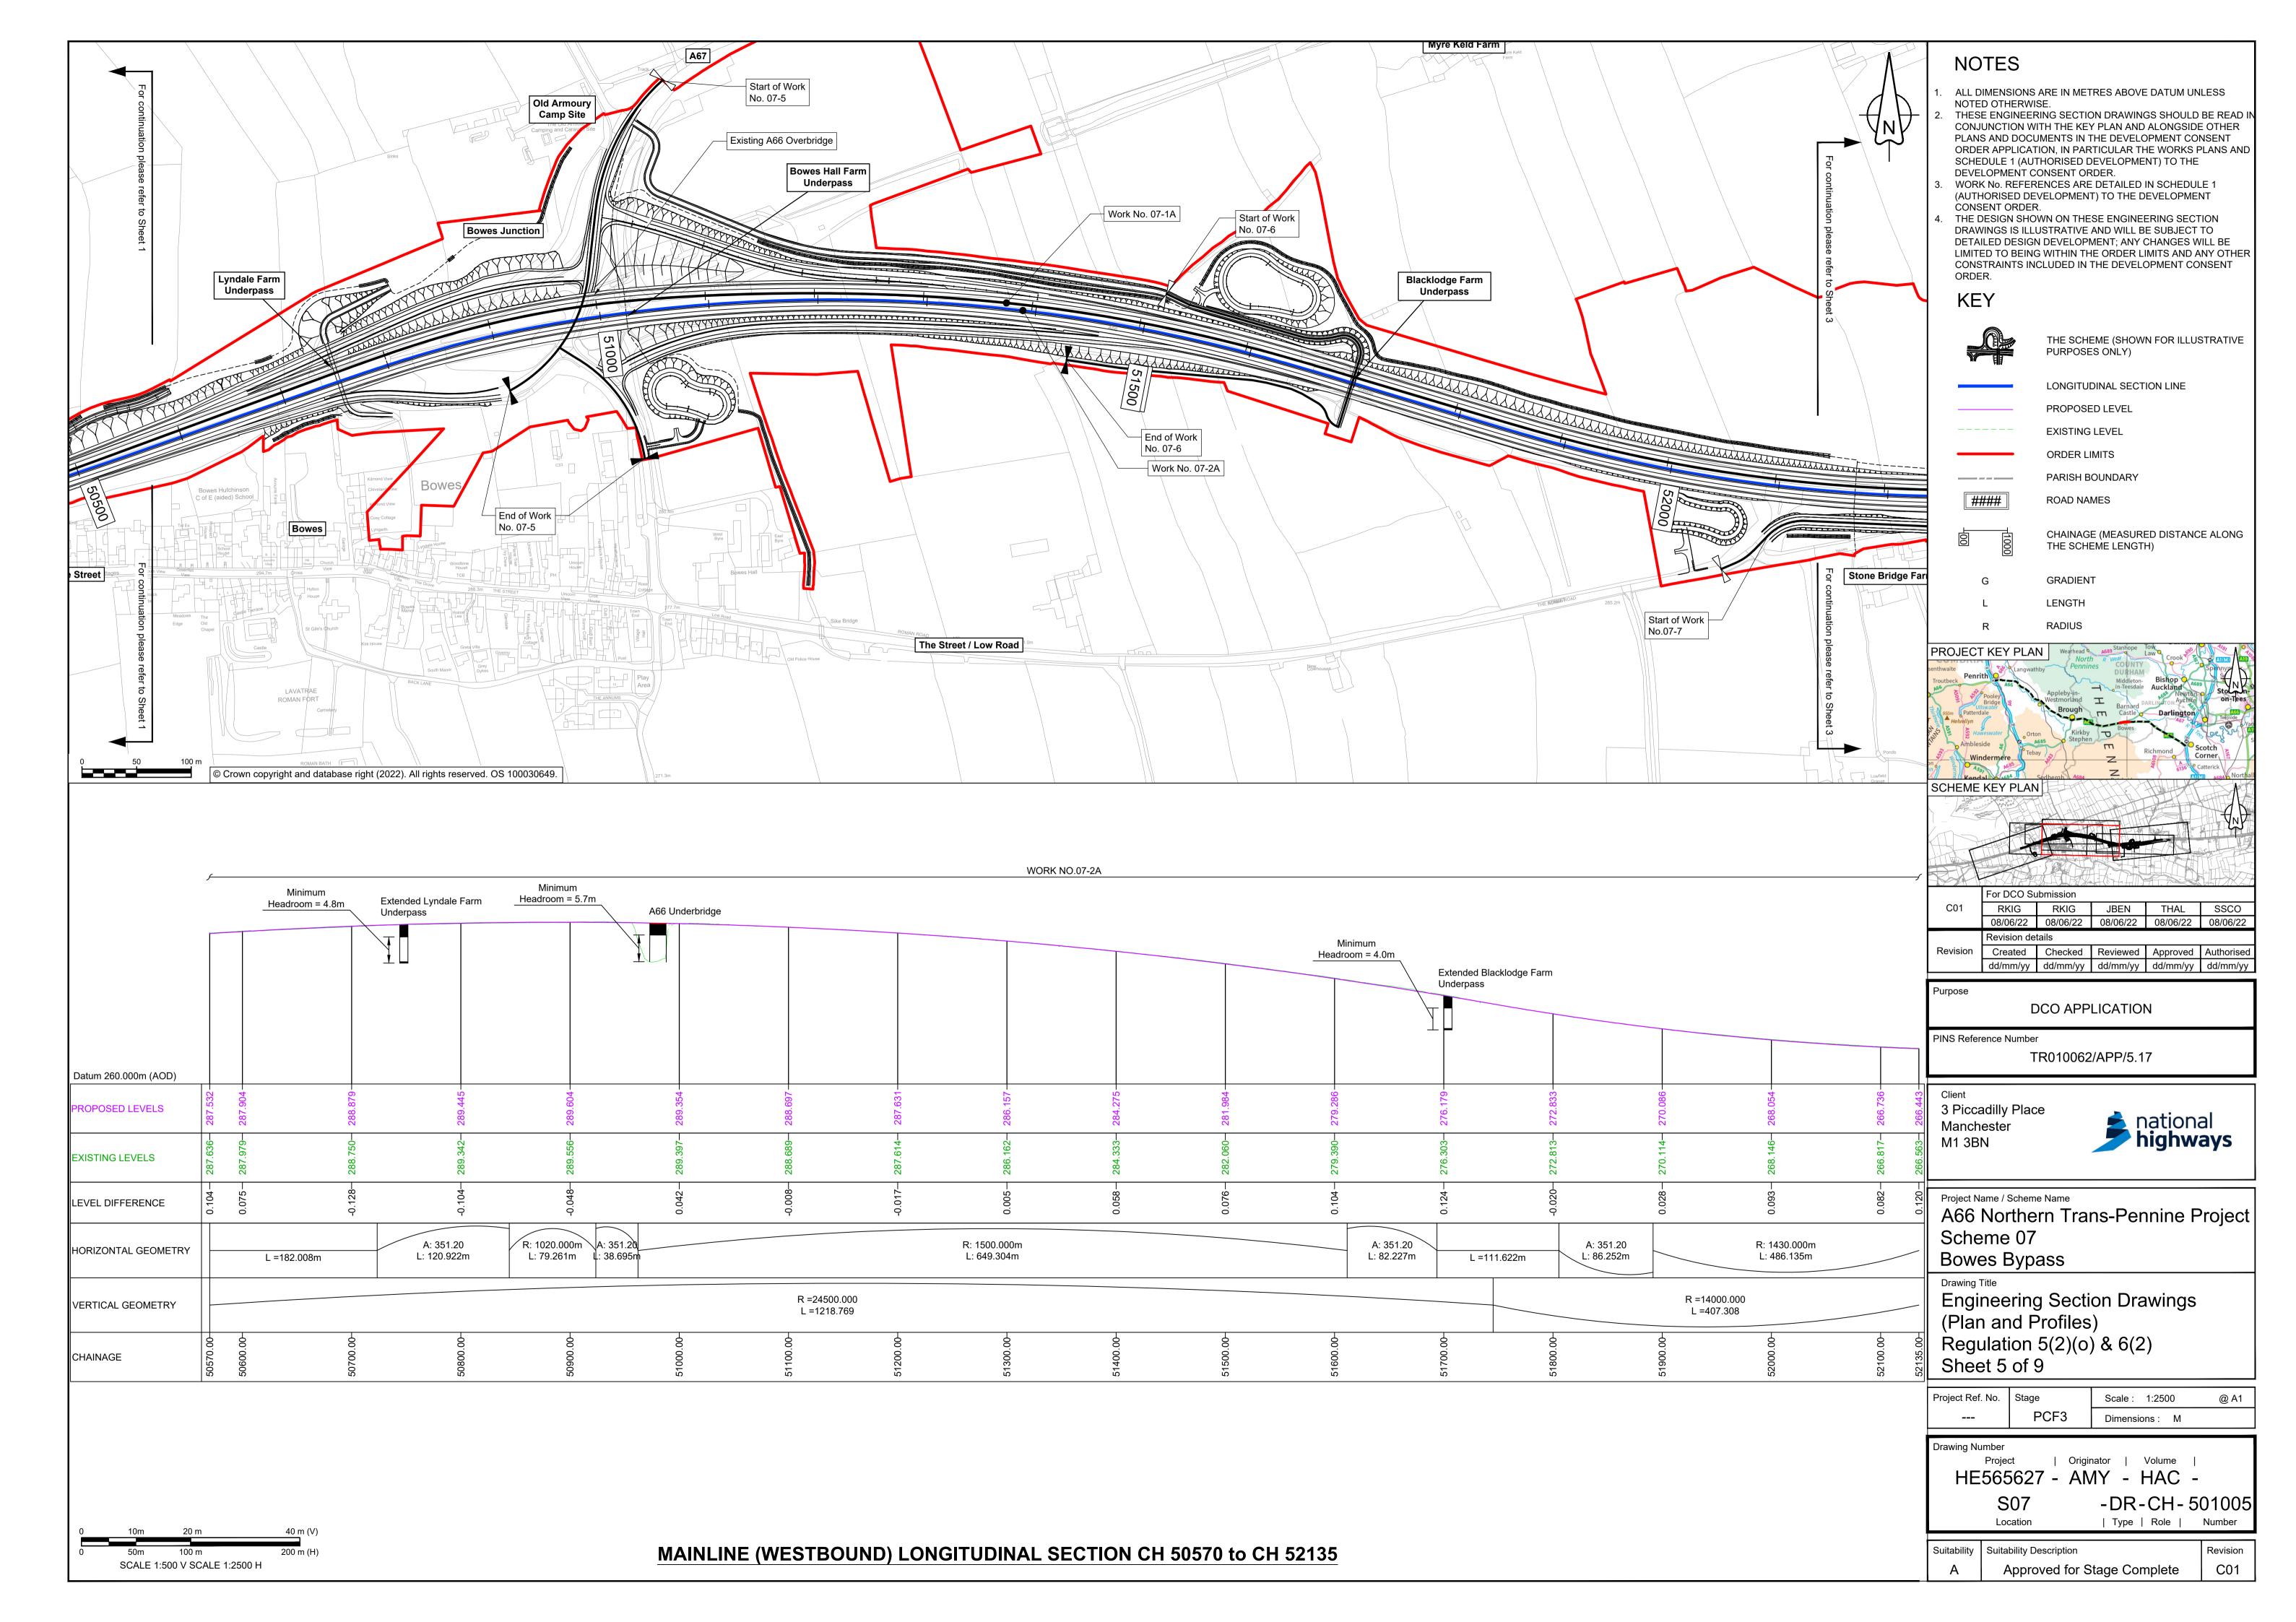

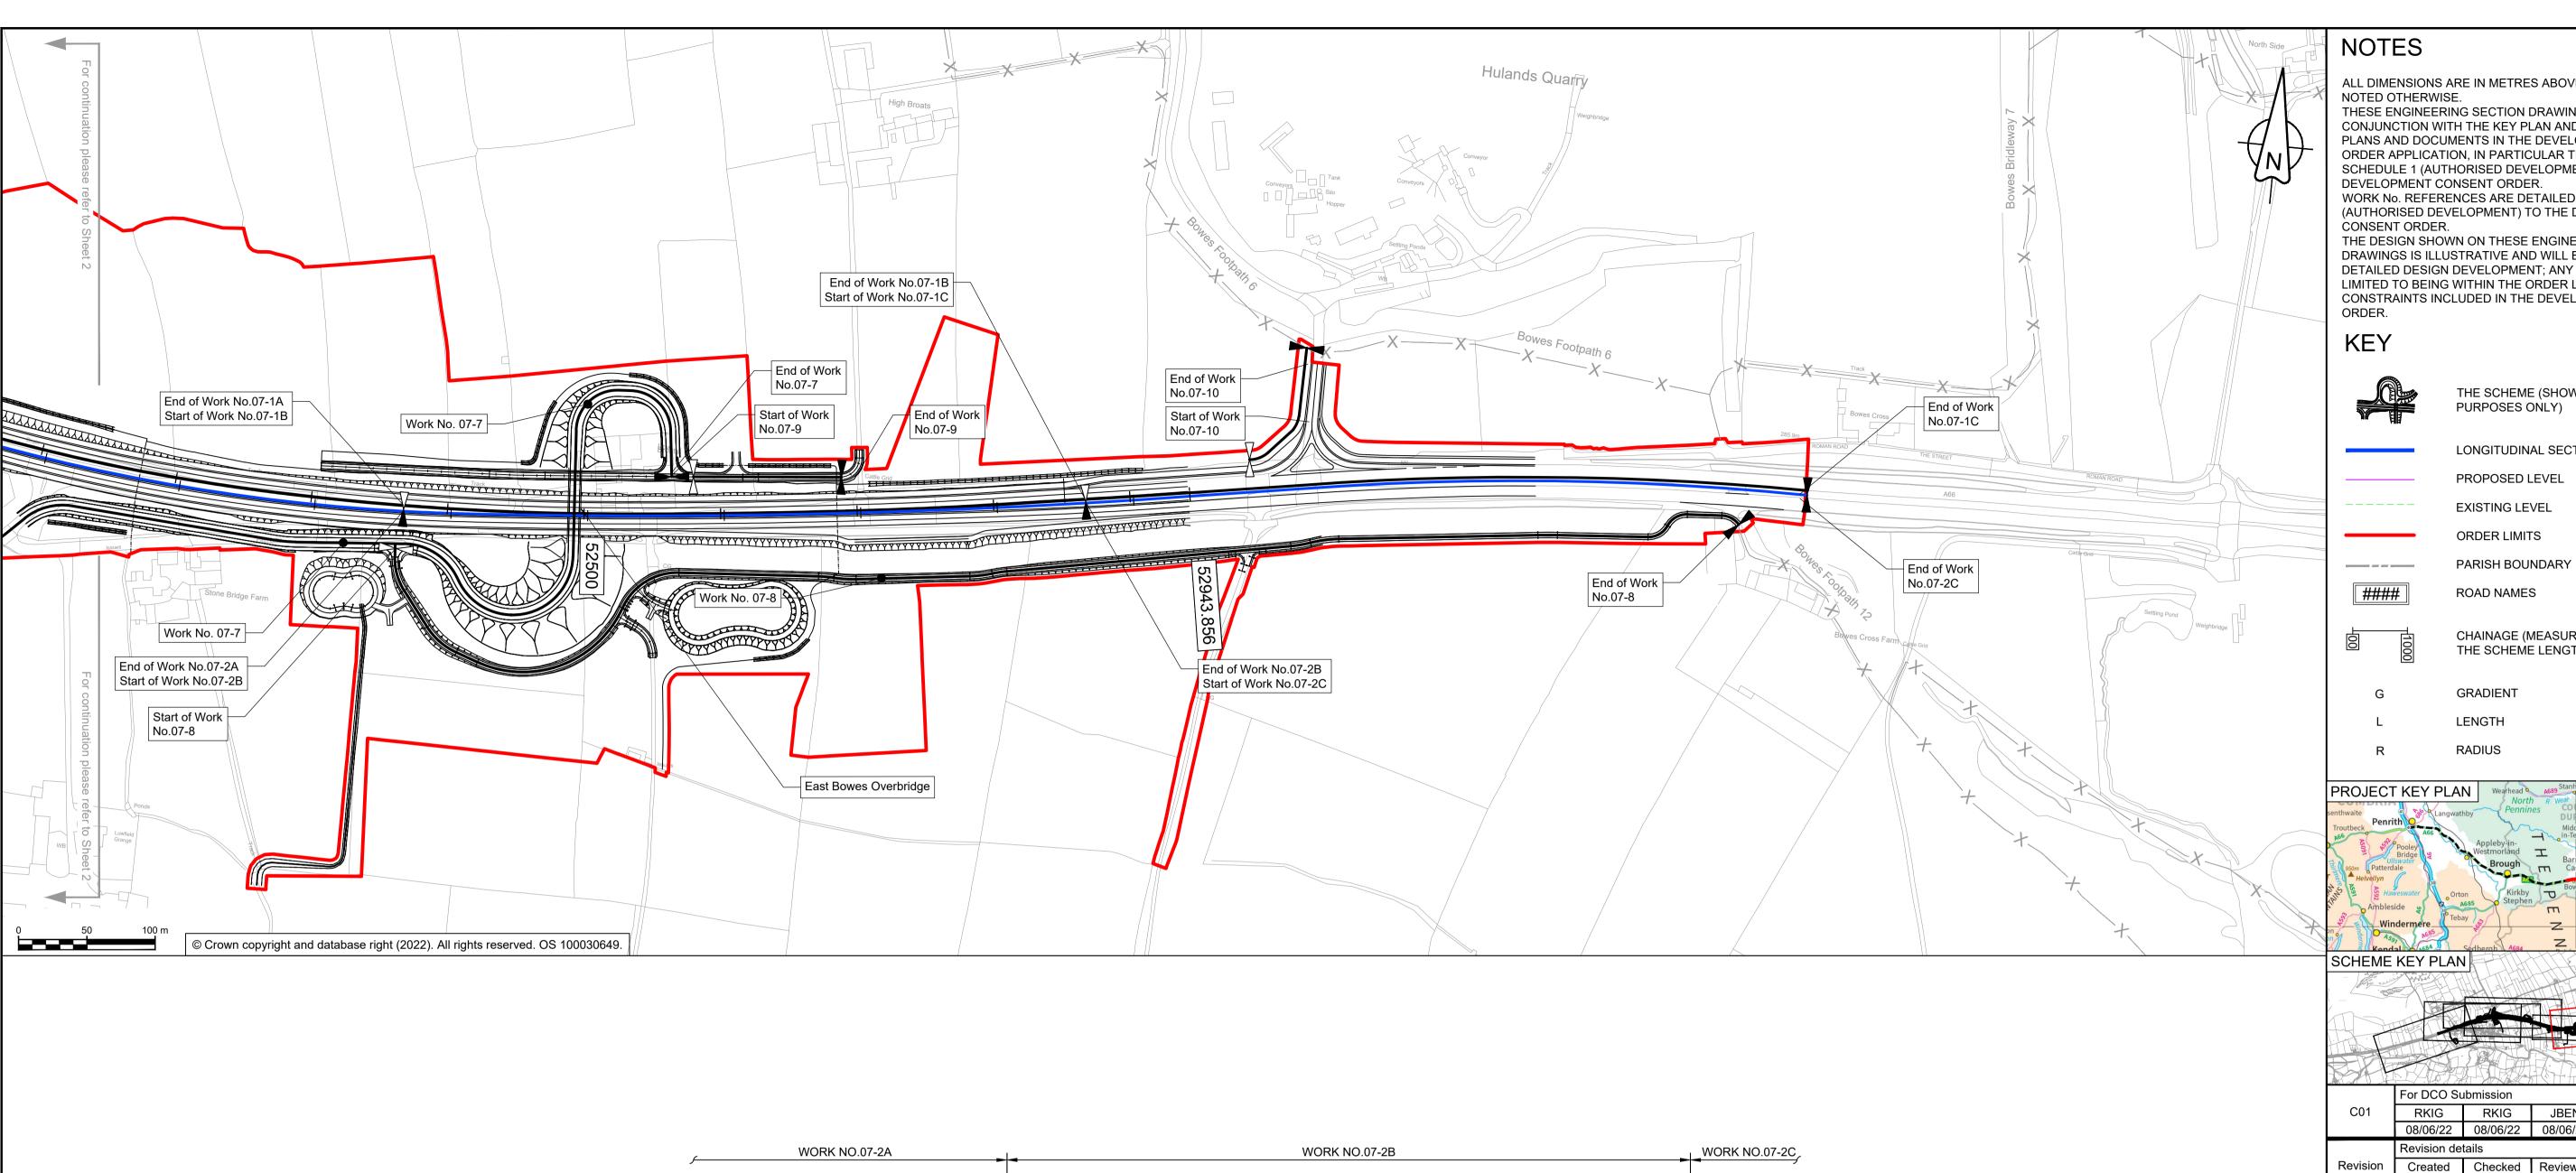

	WOF	RK NO.07-2A	▶ <		WORK NO.07-2	PB		WORK NO.07-2C
			Minimum Headroom = 5.7m	East Bowes A Overbridge	ccomodation			
Datum 260.000m (AOD)								
PROPOSED LEVELS	266.051-	265.465-	264.879-	264.293-	263.772-	263.690-	264.108 -	265.092-
EXISTING LEVELS	266.563—	265.480—	265.032—	264.370—	263.761—	263.695—	264.142—	265.042—
LEVEL DIFFERENCE	0.120-	0.015	0.153	-220.0	-0.011	0.005	0.034	-0.050-
HORIZONTAL GEOMETRY		R: 1430.000m L: 486.135m	A: 348.59 L: 63.203m			R: 5581.528m L: 500.409m		
VERTICAL GEOMETRY		G =- L =3	0.586% 396.709			R =20000.000 L =310.987		R =7500.000 L =81.031
CHAINAGE	52135.00-	52300.00-	52400.00-	52500.00-	52600.00-	52700.00-	52800.00-	52900.00-

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THE SCHEME (SHOWN FOR ILLUSTRATIVE

LONGITUDINAL SECTION LINE

PROPOSED LEVEL

EXISTING LEVEL

CHAINAGE (MEASURED DISTANCE ALONG THE SCHEME LENGTH)



For DCO Submission RKIG RKIG JBEN THAL SSCO 08/06/22 08/06/22 08/06/22 08/06/22 08/06/22

Revision Created Checked Reviewed Approved Authorised dd/mm/yy dd/mm/yy dd/mm/yy dd/mm/yy dd/mm/yy

Purpose

DCO APPLICATION

PINS Reference Number

TR010062/APP/5.17

3 Piccadilly Place Manchester M1 3BN



Project Name / Scheme Name

A66 Northern Trans-Pennine Project Scheme 07 **Bowes Bypass**

Engineering Section Drawings (Plan and Profiles) Regulation 5(2)(o) & 6(2) Sheet 6 of 9

Project Ref. No.	Stage	Scale : 1:2500	@ A1
	PCF3	Dimensions : M	

Drawing Number

| Originator | Volume | HE565627 - AMY - HAC -


> -DR-CH-501006 Location


| Type | Role | Revision


Suitability | Suitability Description

Approved for Stage Complete C01

SCALE 1:500 V SCALE 1:2500 H

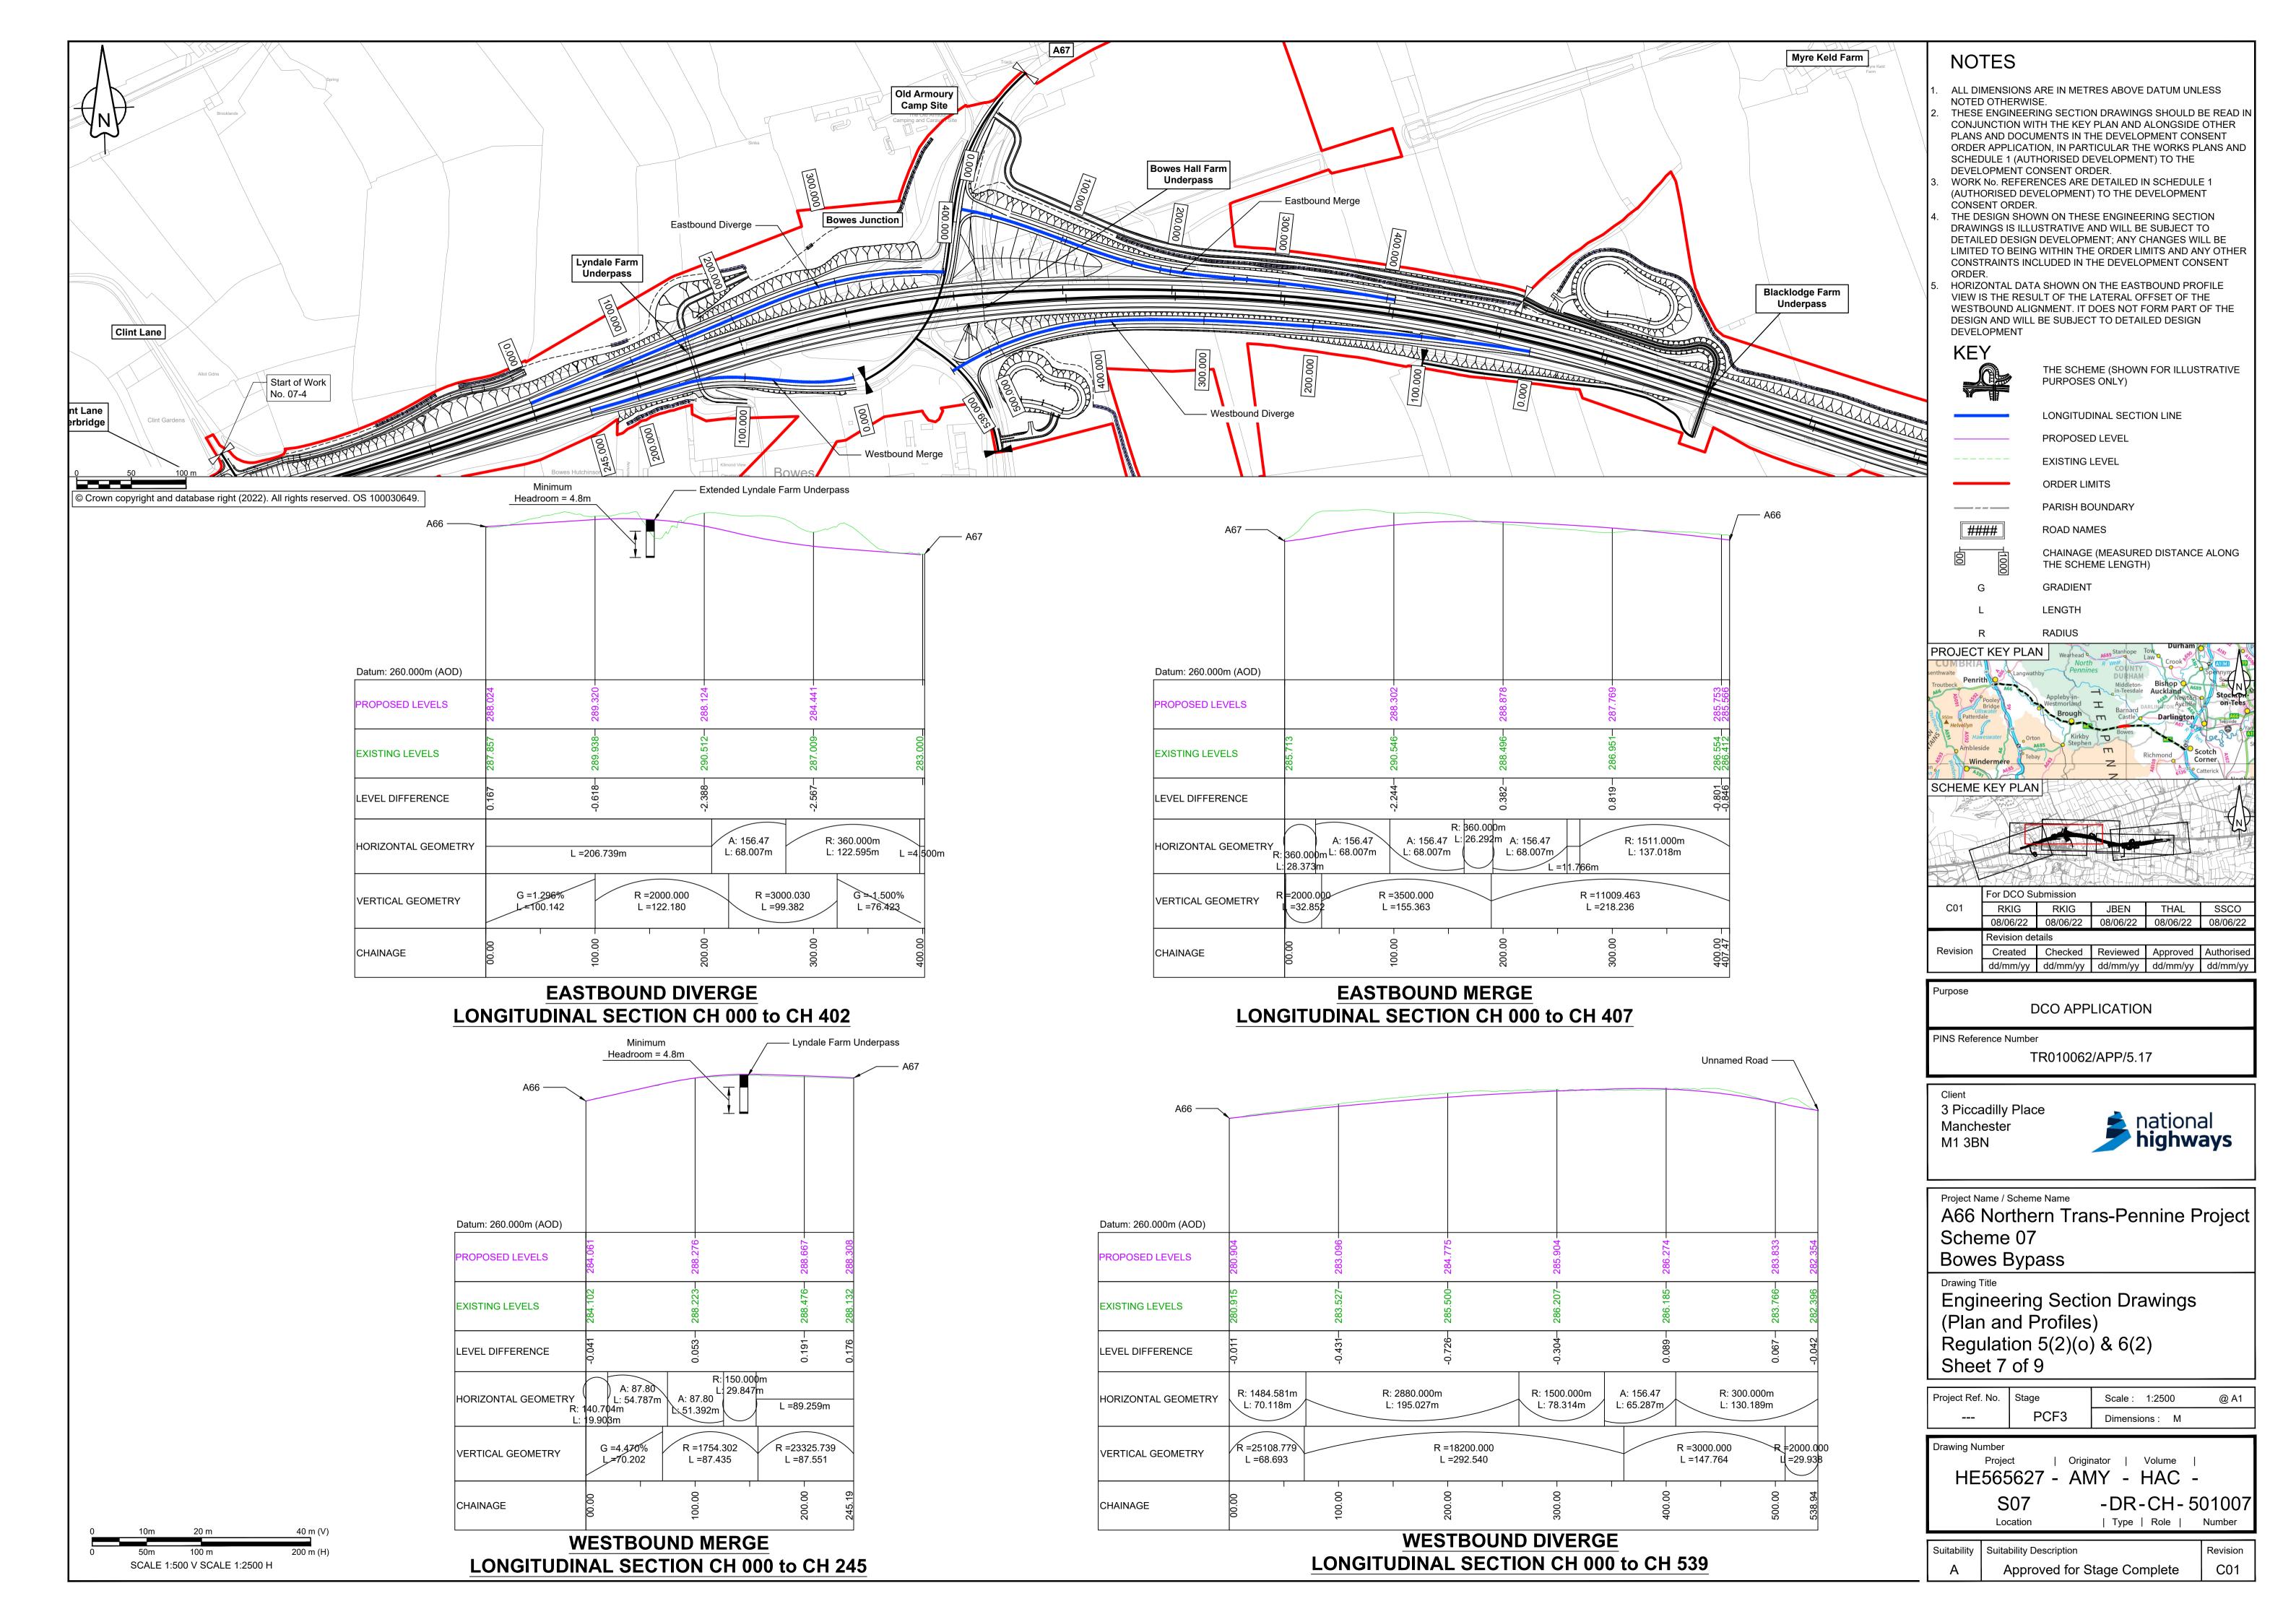

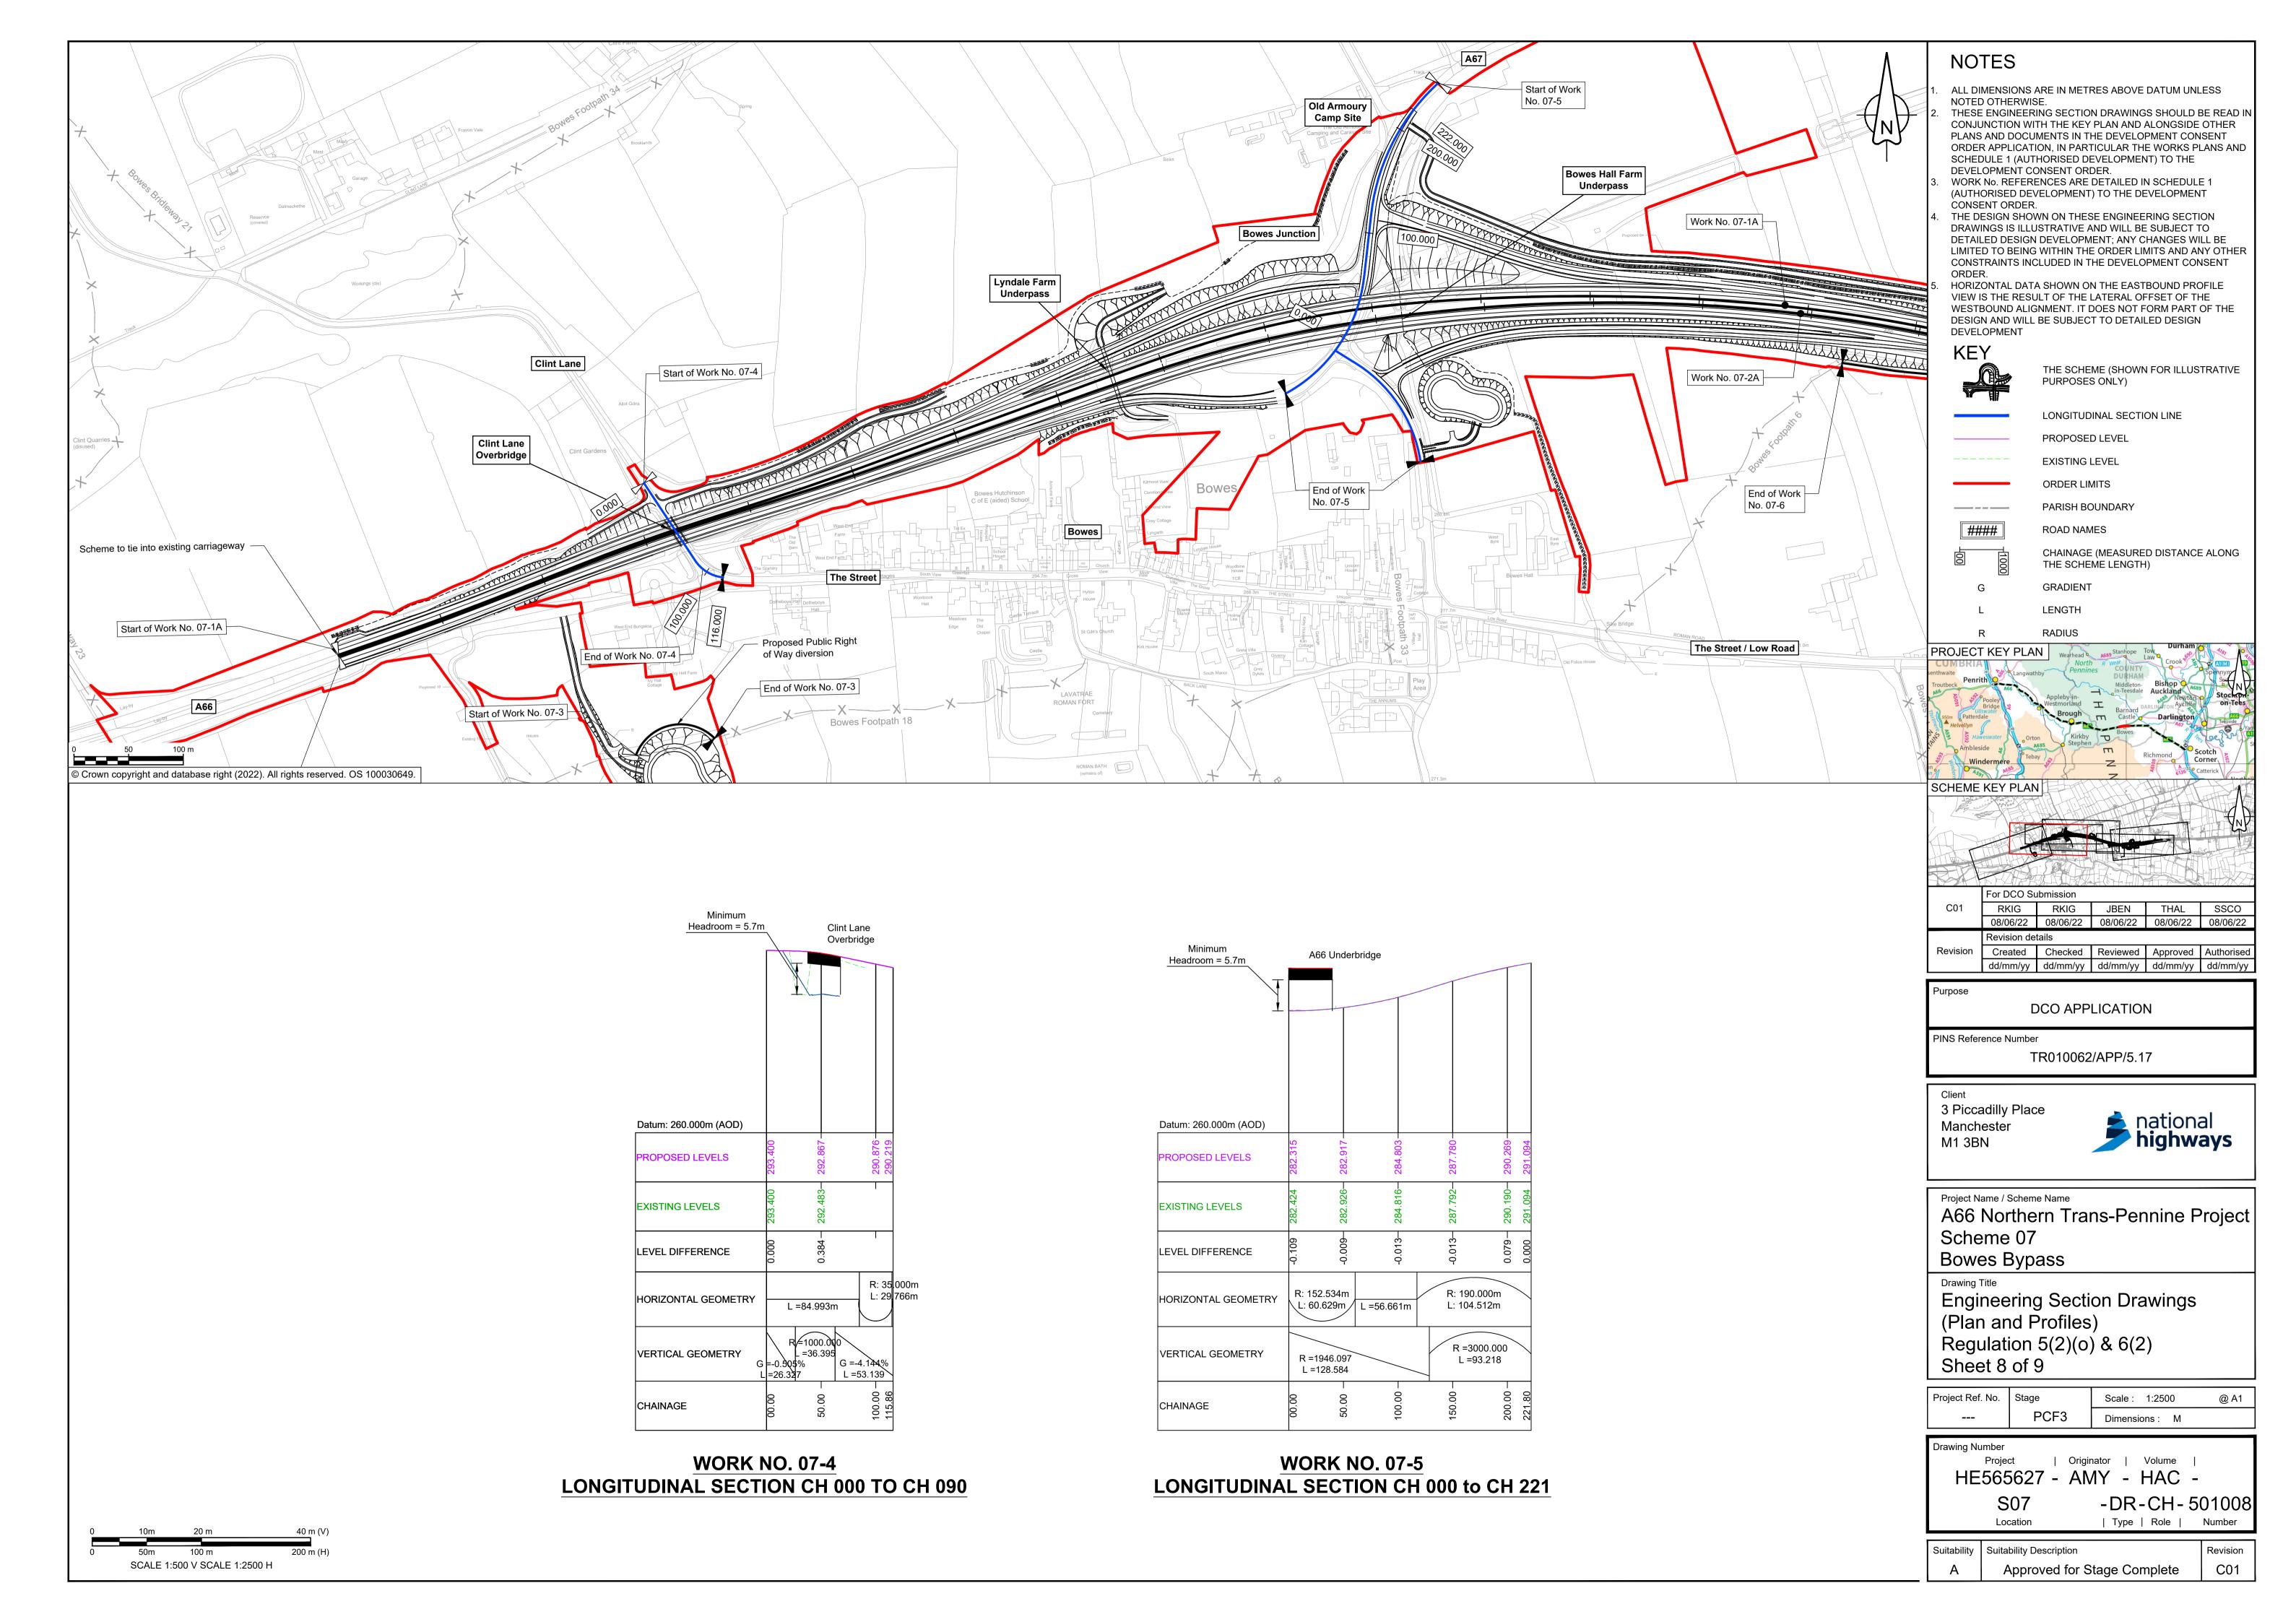

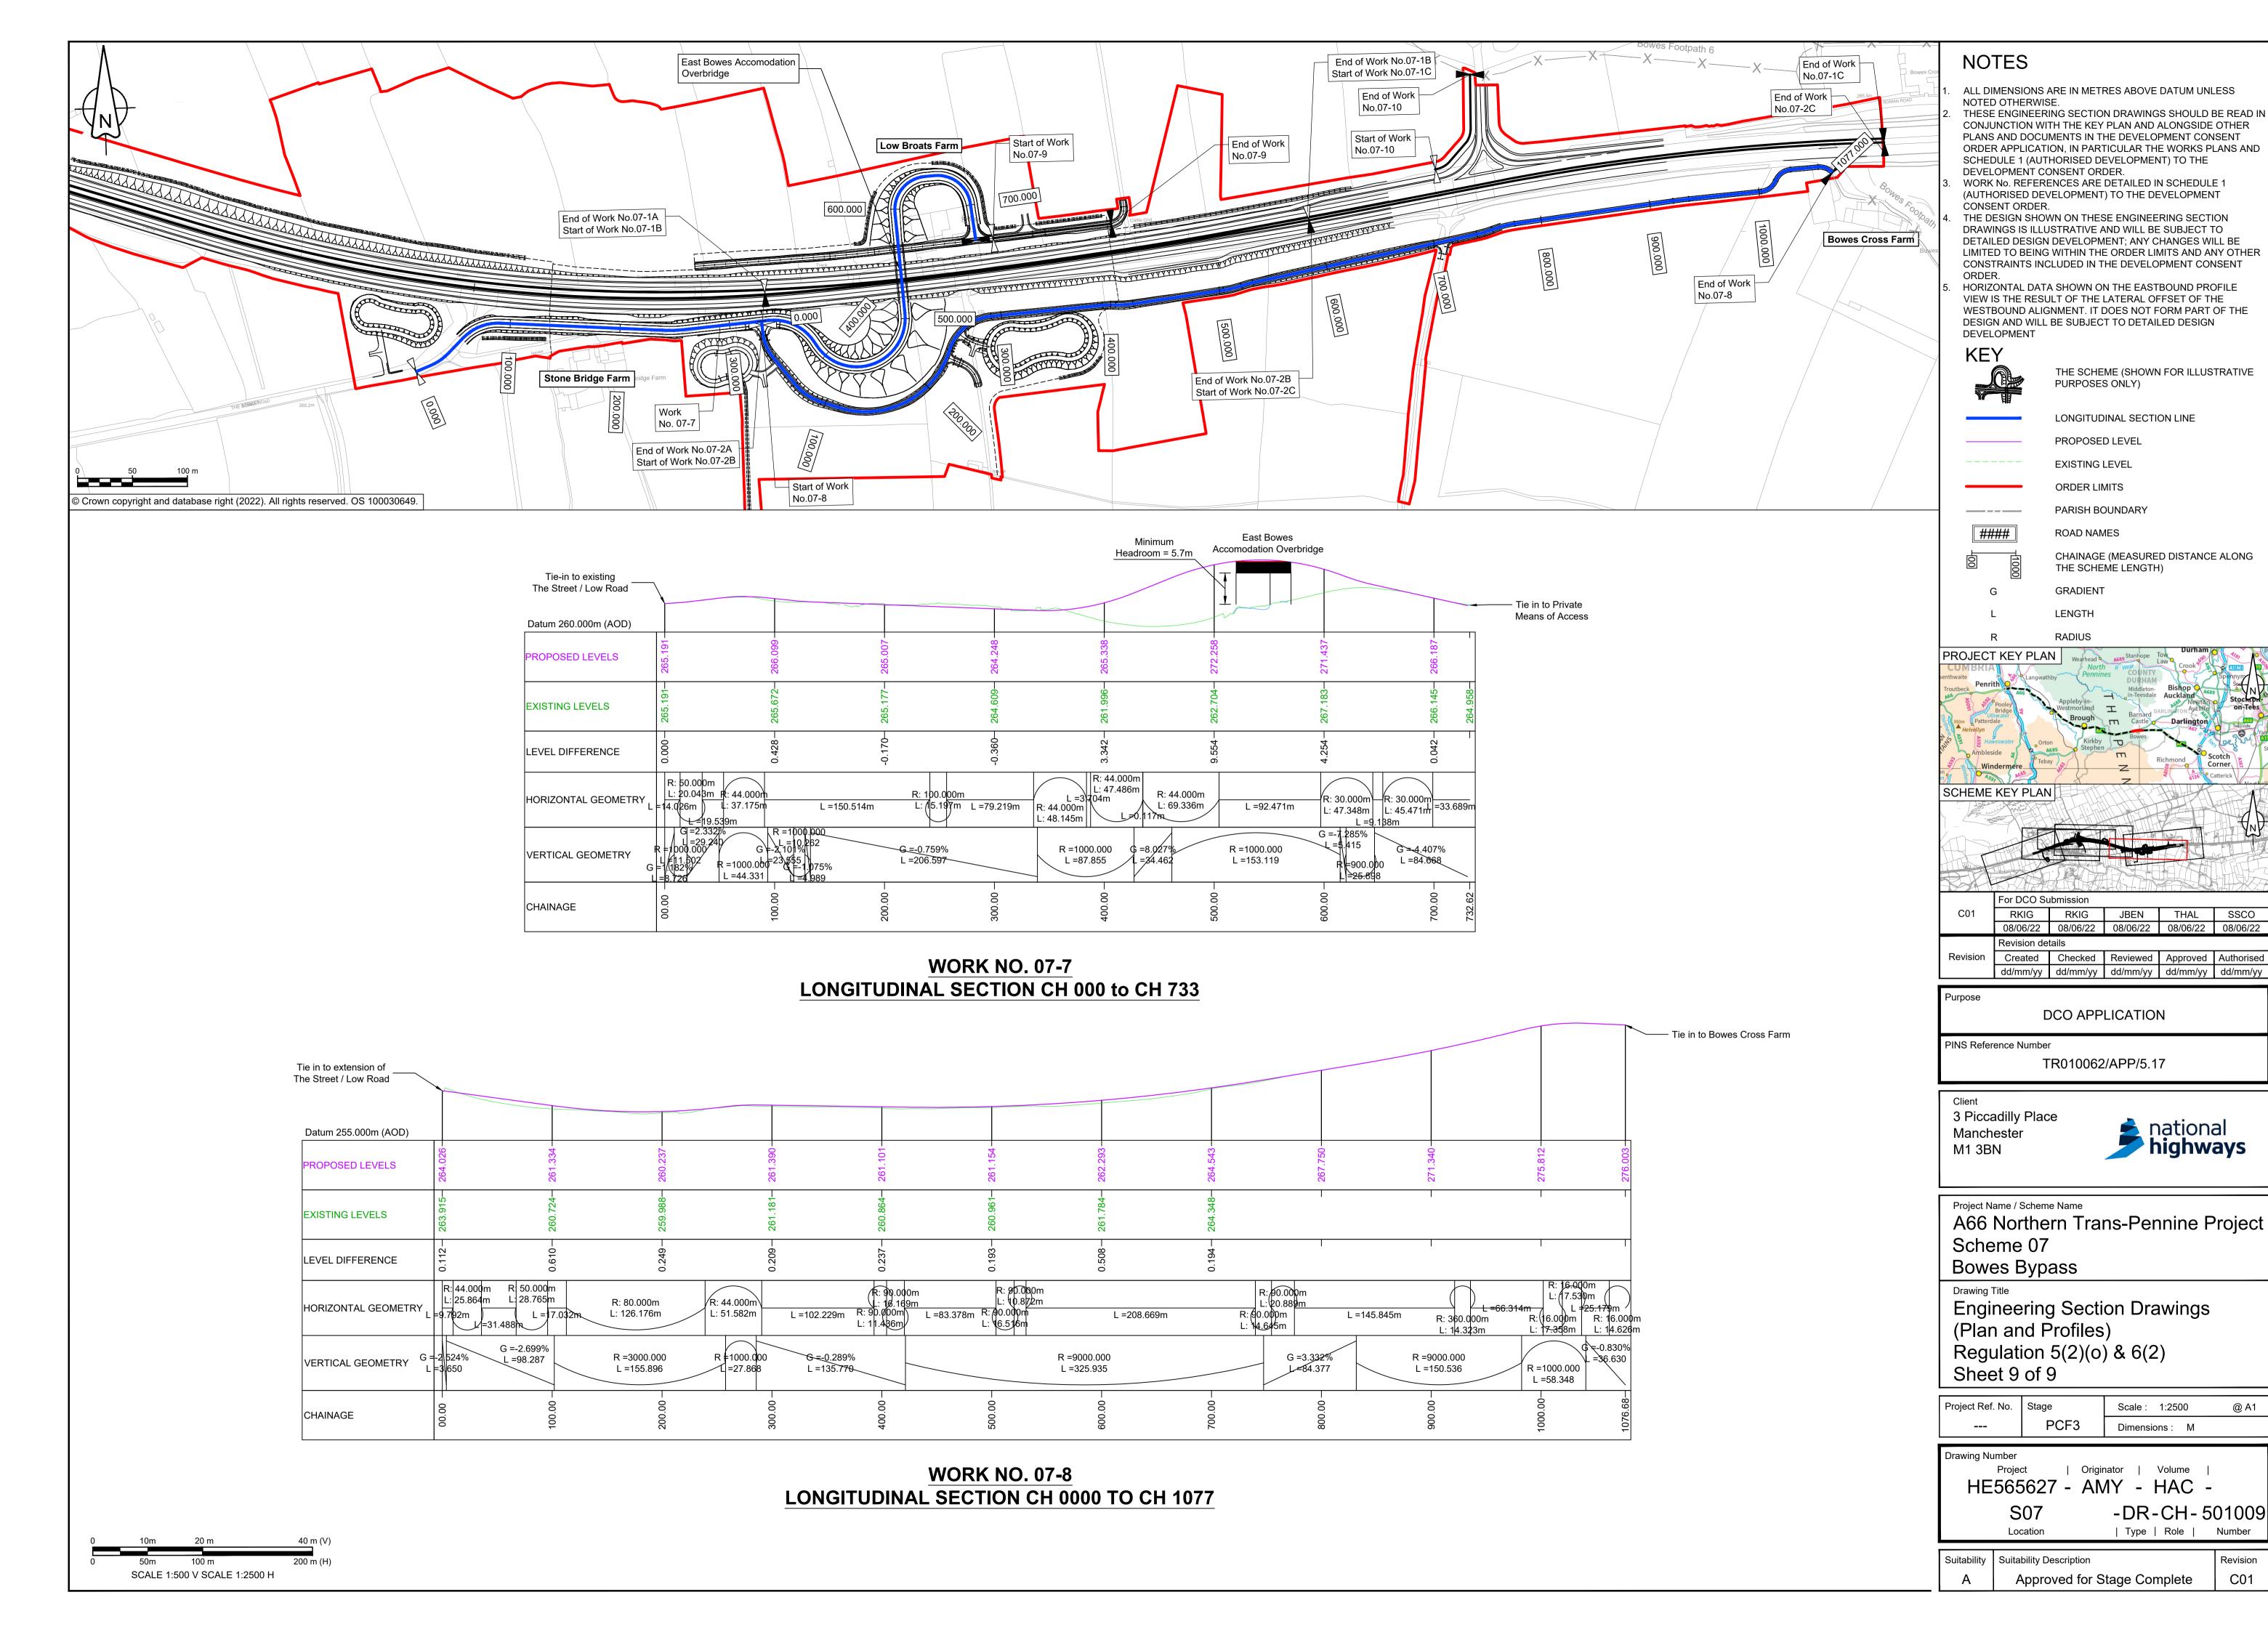

THE SCHEME (SHOWN FOR ILLUSTRATIVE

CHAINAGE (MEASURED DISTANCE ALONG

national highways

Scale: 1:2500

Dimensions: M

| Type | Role |

-DR-CH-501009

PURPOSES ONLY)

PROPOSED LEVEL

ORDER LIMITS

ROAD NAMES

GRADIENT

RADIUS

THE SCHEME LENGTH)

LONGITUDINAL SECTION LINE